OWNER'S / APPLICANT'S CERTIFICATION MANUFACTURERS AND TRADERS TRUST COMPANY (M&T BANK) I, JASON BERNHEIMER, THE UNDERSIGNED AND THE OWNER'S / APPLICANT'S AUTHORIZED REPRESENTATIVE OF THE DRAWINGS INCLUDED HEREIN, DO HEREBY STATE THAT I HAVE REVIEWED THESE DRAWINGS, THEIR CONTENTS, LEGENDS, AND DATA, THAT I AM FAMILIAR WITH SAME AND DO HEREBY CONSENT TO ALL ILLUSTRATIONS, TERMS, AND CONDITIONS NOTED ON THESE DRAWINGS. 5.22.25 VICE PRESIDENT

TITLE

PROPOSED EXTERIOR IMPROVEMENTS TO M&T BANK

527 PIERMONT AVENUE VILLAGE OF PIERMONT **COUNTY OF ROCKLAND, NEW YORK**

PLANNING BOARD APPROVAL
VILLAGE OF PIERMONT

APPROVED BY RESOLUTION OF THE PLANNING BOARD OF THE VILLAGE OF PIERMONT, NEW YORK, ON THE ___20_____, SUBJECT TO ALL REQUIREMENTS AND CONDITIONS OF SAID RESOLUTION. ANY CHANGES, ERASURES, MODIFICATIONS, OR REVISIONS OF THIS PLAN AS APPROVED SHALL VOID THIS APPROVAL. THIS PLAN DOES NOT CONFLICT WITH THE COUNTY OFFICIAL MAP AND HAS BEEN APPROVED IN THE MANNER SPECIFIED BY SECTIONS 239-L AND 239-M OF THE GENERAL MUNICIPAL LAW OF THE STATE OF NEW YORK.

SIGNED	THIS	 DAY	OF

VILLAGE OF PIERMONT PLANNING BOARD CHAIR

ARCHITECT

BATTOGLIA LANZA ARCHITECTURAL GROUP P.C.

209 OLD ROUTE 9, SUITE 5 FISHKILL, NEW YORK 12524

TELEPHONE 845-896-6771 E-MAIL blag@optonline.net

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NOTES

- A. ALL WORK SHALL CONFORM TO THE REQUIREMENTS OF THE 2020 NEW YORK STATE UNIFORM FIRE PREVENTION AND BUILDING CODE, ICC A117.1-09, 2010 ADA STANDARDS FOR ACCESSIBLE DESIGN, REGULATIONS OF THE COUNTY OF ROCKLAND, THE CODE OF THE VILLAGE OF PIERMONT, AND ALL OTHER APPLICABLE CODES AND ORDINANCES. THIS PROJECT REQUIRES IMPLEMENTATION OF WORK BY A SINGLE PRIME CONTRACTOR. C. UNLESS OTHERWISE NOTED THE CONTRACTOR SHALL PAY FOR AND OBTAIN ALL REQUIRED PERMITS NECESSARY FOR THE IMPLEMENTATION OF ITS CONTRACT FROM ANY AND ALL AGENCIES HAVING JURISDICTION AND SHALL ARRANGE FOR ALL INSPECTIONS AS MAY BE REQUIRED. THE OWNER SHALL BE RESPONSIBLE FOR PAYING FOR AND OBTAINING A BUILDING PERMIT. THE CONTRACTOR SHALL BE RESPONSIBLE FOR OBTAINING A CERTIFICATE OF OCCUPANCY OR
- CERTIFICATE OF COMPLIANCE AS THE CASE MAY BE D. THE CONTRACTOR SHALL VERIFY AND COORDINATE ALL DIMENSIONS AND CONDITIONS IN THE FIELD PRIOR TO COMMENCEMENT OF CONSTRUCTION, FABRICATION, OR MANUFACTURING.
- E. AMONG OTHER REQUIRED NOTIFICATIONS TO THE BUILDING DEPARTMENT, THE CONTRACTOR SHALL NOTIFY THE BUILDING DEPARTMENT FOR ALL REQUIRED INSPECTIONS RELATING TO WORK UNDER ITS CONTRACT THE CONTRACTOR SHALL COOPERATE AND COORDINATE THE WORK OF ITS TRADES. SAME SHALL BE DONE PRIOR TO THE ORDERING, FABRICATION, AND CONSTRUCTION OF THE RESPECTIVE ASSEMBLIES AND SYSTEMS.
- G. ALL WORK SHALL BE PERFORMED IN ACCORDANCE WITH THE REQUIREMENTS OF THESE CONTRACT DOCUMENTS. INCLUDING ALL STANDARDS ADOPTED BY REFERENCE HEREIN. ALL WORK SHALL ALSO BE PERFORMED IN ACCORDANCE WITH THE REQUIREMENTS AND RECOMMENDATIONS OF THE MANUFACTURERS WHOSE ITEMS ARE BEING INCORPORATED INTO THE WORK, BUT IN NO CASE SHALL THE CONTRACTOR BE RELIEVED OF THE MINIMUM REQUIREMENTS SPECIFIED IN THESE CONTRACT DOCUMENTS. ALL WORK SHALL MEET OR EXCEED THE REQUIREMENTS OF ALL APPLICABLE CODES AND ORDINANCES
- THE CONTRACTOR SHALL PREPARE AN INITIAL WORK SCHEDULE THAT SHALL INCLUDE THE WORK OF ALL TRADES AND IT SHALL COMPLY WITH THE REQUIRED DATE OF SUBSTANTIAL COMPLETION. SAME SHALL BE REVIEWED BY THE OWNER, WHICH SHALL OFFER COMMENTS AND SUGGESTIONS, AND OTHERWISE COOPERATE WITH THE CONTRACTOR AS REQUIRED TO REVISE AND FINALIZE THE WORK SCHEDULE SO THAT IT IS AGREEABLE TO THE CONTRACTOR AND THE OWNER, WHILE COMPLYING WITH THE REQUIRED DATE OF SUBSTANTIAL COMPLETION. ONCE THE WORK SCHEDULE IS APPROVED THE CONTRACTOR SHALL STRICTLY ADHERE TO SAME AND TAKE WHATEVER STEPS ARE NECESSARY TO THE CONTRACTOR SHALL KEEP THE OWNER INFORMED OF ITS WORK SCHEDULE AND SHALL COORDINATE ITS SCHEDULE
- WITH THE OWNER'S OPERATIONS J. ALL BUILDING PENETRATIONS, AS MAY BE REQUIRED, SHALL BE PROTECTED FROM THE ELEMENTS OF WEATHER AND ALL SAFETY PRECAUTIONS AS REQUIRED TO PROTECT ALL PEOPLE AND PROPERTY FROM HAZARDOUS CONDITIONS
- K. SHORING AND BRACING SHALL BE PROVIDED AS REQUIRED TO MAINTAIN THE INTEGRITY OF THE EXCAVATIONS. STRUCTURES, AND THE WORK DURING THE CONSTRUCTION OPERATION UNTIL ALL PERMANENT STRUCTURAL
- COMPONENTS ARE INSTALLED, ANCHORED, AND BRACED. CONSTRUCTION MEANS, METHODS, AND SEQUENCES SHALL BE THE RESPONSIBILITY OF THE CONTRACTOR. M. SITE SAFETY DURING THE COURSE OF CONSTRUCTION SHALL BE THE RESPONSIBILITY OF THE CONTRACTOR. N. THE CONTRACTOR SHALL NOTIFY THE OWNER OF ANY DISCREPANCIES BETWEEN THE EXISTING CONDITIONS REPRESENTED BY THE CONTRACT DOCUMENTS / ASSUMED EXISTING CONDITIONS AND ACTUAL EXISTING CONDITIONS
- PRIOR TO ANY WORK BEING DONE INVOLVING SUCH CONDITIONS. O. THE CONTRACTOR SHALL IMMEDIATELY NOTIFY THE OWNER OF ANY CONDITION THAT, IN ITS OPINION, MIGHT ENDANGER THE STABILITY OF ANY STRUCTURE OR CAUSE DISTRESS TO ANY STRUCTURE. P. IT IS PARAMOUNT THAT INCONVENIENCES TO EXISTING PROJECT OPERATIONS, ADJACENT BUSINESSES, RESIDENCES, DRIVERS, AND THE GENERAL PUBLIC BE KEPT TO A MINIMUM. ACCORDINGLY, THE CONTRACTOR SHALL COORDINATE THE SEQUENCE OF ITS WORK OPERATIONS AND SHALL RECEIVE THE OWNER'S APPROVAL OF SAME PRIOR TO THE
- COMMENCEMENT OF WORK. THE GRANTING OF SUCH APPROVAL SHALL NOT RELIEVE THE CONTRACTOR OF ITS RESPONSIBILITY TO MINIMIZE INCONVENIENCES AND DISRUPTIONS. Q. THE CONTRACTOR SHALL COORDINATE THE REQUIREMENTS OF THE CONTRACT DOCUMENTS PREPARED BY THE BATTOGLIA LANZA ARCHITECTURAL GROUP, PC WITH THE DESIGNS OF THE REQUIRED SYSTEMS AS PREPARED BY
- OTHERS. SAME SHALL BE DONE PRIOR TO THE MANUFACTURING, FABRICATION, AND CONSTRUCTION OF THE RESPECTIVE ASSEMBLIES AND SYSTEMS. R. ALL WORK INDICATED IN THESE CONTRACT DOCUMENTS SHALL BE NEW WORK UNLESS OTHERWISE NOTED.

WITH REGARD TO MATERIALS, COLORS, TEXTURES, AESTHETICS, AND STRUCTURAL INTEGRITY.

- 5. THE CONTRACTOR SHALL PROTECT ALL EXISTING AND NEW WORK, ANY WORK DAMAGED BY THE CONTRACTOR SHALL BE REPAIRED OR REPLACED TO THE SATISFACTION OF THE OWNER AT THE EXPENSE OF THE CONTRACTOR. THE CONTRACTOR SHALL BE RESPONSIBLE FOR ANY CUTTING, PATCHING, PAINTING, AND FINISHING THAT IS MADE NECESSARY BY THE RESPECTIVE WORK OF THE CONTRACTOR PATCHING AND FINISHING SHALL BE ACCOMPLISHED WITH THE SAME MATERIALS THAT WERE CUT OUT AND THE CONDITIONS SHALL BE RESTORED TO THE OWNER'S SATISFACTION
- A. DEMOLITION WORK SHALL BE THE RESPONSIBILITY OF THE CONTRACTOR.
- B. ALL MATERIALS, EQUIPMENT, DEBRIS, ETC., BEING DEMOLISHED SHALL BECOME THE PROPERTY OF THE CONTRACTOR, UNLESS SPECIFICALLY NOTED OTHERWISE. SAME SHALL BE REMOVED FROM THE PREMISES BY THE CONTRACTOR FOR DISPOSAL ELSEWHERE. ALL DISPOSAL SHALL BE DONE IN ACCORDANCE WITH LOCAL, COUNTY, STATE, AND FEDERAL
- C. ALL SITE WORK, GENERAL CONSTRUCTION, PLUMBING, HVAC, ELECTRICAL, LIFE SAFETY, TELEPHONE, DATA, AUDIO-VISUAL, COMMUNICATION, AND OTHER WORK SHALL BE REMOVED BY THE CONTRACTOR AS REQUIRED FOR THE INSTALLATION OF THE NEW WORK, SUCH RESPECTIVE SYSTEMS SHALL BE REPLACED AND/OR RECONNECTED BY THE CONTRACTOR AS SPECIFIED OR IMPLIED AS REQUIRED TO BE CONSISTENT WITH THE INTENT OF THE SYSTEMS AND TO MEET ALL APPLICABLE CODES AND STANDARDS. GENERALLY, ITEMS WHOSE REMOVAL OR RELOCATION IS REQUIRED ARE REPRESENTED BY HIDDEN (DASHED) LINES ON THE DEMOLITION DRAWINGS. HOWEVER IT SHALL NOT BE ASSUMED THAT ALL ITEMS REPRESENTED BY HIDDEN (DASHED) LINES ON THE DRAWINGS ARE SCHEDULED FOR REMOVAL OR
- D. SHORING AND BRACING SHALL BE PROVIDED AS REQUIRED TO MAINTAIN THE INTEGRITY OF THE EXCAVATIONS, STRUCTURES, SYSTEMS, AND THE WORK DURING THE CONSTRUCTION OPERATION UNTIL ALL PERMANENT STRUCTURAL
- COMPONENTS ARE INSTALLED, CURED, ANCHORED AND BRACED. E. ALL STRUCTURES SCHEDULED FOR REMOVAL SHALL INCLUDE THEIR RESPECTIVE FOUNDATIONS, UNLESS OTHERWISE F. WHERE VEGETATION IS SCHEDULED FOR REMOVAL, OR IS OTHERWISE REQUIRED TO BE REMOVED IN ORDER TO
- PERFORM OTHER WORK, THE CONTRACTOR SHALL COMPLETELY REMOVE THE RESPECTIVE STUMPS AND ROOT
- G. THE OWNER SHALL REMOVE ITEMS AS IS REASONABLY REQUIRED FOR THE CONTRACTOR TO PERFORM ITS WORK, TO THE EXTENT THAT THE OWNER WISHES SUCH ITEMS TO BE REINSTALLED, THE OWNER SHALL REINSTALL SAME.
- A. THE CONTRACTOR SHALL BE RESPONSIBLE FOR ALL CUTTING, FILLING, GRADING, EXCAVATION, FILL, BACKFILL, SUBBASE, BEDDING, AND COMPACTION AS REQUIRED FOR ALL WORK. B. UNLESS OTHERMISE NOTED, ALL FILL AND BACKFILL SHALL BE A POROUS GRAVEL MATERIAL CONFORMING TO THE

FOLLOWING GRADATION: GRADING PERCENT PASSING BY WEIGHT SQUARE MESH SIEVES PASS 3 1/2" 90-100

PASS NO. 10 15-45 PASS NO 40 PASS NO. 100 0-10 PASS NO. 200

PASS 1 1/2"

- C. ALL SUBBASE MATERIAL UNDER BITUMINOUS CONCRETE PAVING, EXTERIOR CONCRETE SLABS, WALKS, RAMP, TRENCH DRAINS, AND CATCH BASINS SHALL BE NYSDOT TYPE 2 (304-2). D. ALL SUBBASE, FILL, AND BACKFILL MATERIAL, AS WELL AS SUBGRADES SHALL BE COMPACTED TO 95% OF MAXIMUM DRY DENSITY OBTAINABLE UNDER ASTM DESIGNATION D1557 METHOD D.
- E. UNLESS OTHERWISE NOTED ALL GROUND SURFACE AREAS DISTURBED, CUT, OR FILLED SHALL RECEIVE 4" MINIMUM OF TOPSOIL AND SHALL BE SEEDED AND MULCHED (45% KENTUCKY BLUEGRASS, 25% RED FESCUE AND 30% PERENNIAL F. ALL IMPORTED (BORROW) SOILS SHALL MEET THE REQUIREMENTS FOR UNRESTRICTED USE SOIL CLEANUP OBJECTIVES SPECIFIED UNDER NEW YORK STATE DEPARTMENT OF ENVIRONMENTAL CONSERVATION (NYSDEC) CHAPTER IV-QUALITY SERVICES, SUBPART 375-6 AND NYSDEC CP-51 SOIL GUIDANCE POLICY. THE CONTRACTOR SHALL PROVIDE SUFFICIENT
- REQUIREMENTS. SUCH EVIDENCE SHALL BE PROVIDED AND APPROVED BY THE OWNER PRIOR TO IMPORTING SUCH G. BIDDERS ARE ENCOURAGED TO PERFORM ANY SITE EXPLORATION THAT THEY BELIEVE IS NECESSARY TO FULLY INFORM THEMSELVES OF SUBSURFACE CONDITIONS IN THE WORK AREA PRIOR TO THEIR SUBMISSION OF BIDS. ARRANGEMENTS FOR SUCH EXPLORATION SHALL BE MADE WITH. AND APPROVED BY, THE OWNER PRIOR TO THE BIDDER ACCESSING THE SITE (CERTIFICATES OF INSURANCE AND AN INDEMNIFICATION SATISFACTORY TO THE OWNER'S ATTORNEY WILL ALSO BE CONDITIONS OF SUCH SITE ACCESS). ALL WORK SHALL BE INCLUDED IN THE BASE BIDS AS REQUIRED TO ACCOMMODATE ACTUAL SUBSURFACE CONDITIONS AND THE CONTRACTOR SHALL NOT BE ENTITLED TO

ADDITIONAL COMPENSATION FOR FAILURE TO INFORM ITSELF OF THE ACTUAL CONDITIONS PRIOR TO ITS SUBMISSION

DOCUMENTARY EVIDENCE TO THE OWNER THAT SOILS PROPOSED FOR IMPORTATION COMPLY WITH SUCH

- A. ALL CONCRETE WORK, SHALL BE THE RESPONSIBILITY OF THE CONTRACTOR. B. ALL DETAILING. FABRICATION. AND PLACING OF REINFORCING MUST FOLLOW THE ACI MANUAL OF STANDARD PRACTICE FOR DETAILING REINFORCED CONCRETE STRUCTURES (ACI 315 - LATEST EDITION), UNLESS OTHERWISE NOTED. C. THE BUILDING CODE REQUIREMENTS FOR REINFORCED CONCRETE (ACI 318) SHALL GOVERN FOR ALL CONCRETE D. REINFORCING BARS SHALL CONFORM TO ASTM A615 - GRADE 60. WELDED WIRE REINFORCEMENT (WWR) SHALL COMPLY WITH ASTM A1064 AND SHALL BE SUPPLIED IN SHEETS (NOT ROLLS).
- E. ALL REINFORCING SHALL BE CONTINUOUS AND SHALL HAVE LAPPED SPLICES WITH HOOKS AT CORNERS AND NON-F. UNLESS OTHERWISE NOTED, MINIMUM LAPS OR EMBEDMENT SHALL BE 30 BAR DIAMETERS. G. WELDED WIRE REINFORGING SHALL HAVE END AND SIDE LAPS OF ONE FULL MESH AND SHALL BE EXTENDED FULLY
- INTO END CONDITION, UNLESS OTHERWISE NOTED. H. BAR AND WELDED WIRE REINFORCEMENT PROTECTION SHALL BE AS INDICATED IN THE DETAILS. DETAILING AND AMOUNT OF REINFORCING FOR CONDITIONS NOT SHOWN ON THESE DRAWINGS SHALL BE PROVIDED AS SHOWN IN SIMILAR CONDITIONS. CONTRACTOR SHALL ACCOMMODATE AND COORDINATE OTHER OBJECTS THAT MAY
- AFFECT PLACEMENT OF REINFORCEMENT BARS, WELDED WIRE REINFORCING, DOWELS, AND OTHER ITEMS. I. CONCRETE CLASSES (ALL CONCRETE SHALL BE NORMAL WEIGHT) NOT USED. NOT USED.
- NOT USED 6. RETAINING WALLS, EXTERIOR SLABS, WALKS, PADS, RAMP, CURBS, AND TRENCH DRAINS - 4000 PSI AT 28 DAYS, 2" TO 4" SLUMP, AGGREGATE SIZE 3/4" TO NO. 4, AIR ENTRAINING AGENT (4.5% TO 7.5%), WATER REDUCING ADMIXTURE (BROOM FINISH SHALL BE PROVIDED PERPENDICULAR TO THE PATH OF TRAVEL ON ALL EXTERIOR SLABS. WALKS, PADS, RAMP, AND WALKING SURFACES OF RETAINING WALLS, CURBS, AND TRENCH DRAINS). K. WATER REPELLANT - SUBSEQUENT TO CURING, ALL EXPOSED EXTERIOR CONCRETE (EXCLUDING INTERIOR OF TRENCH
- DRAINS) SHALL BE PROTECTED WITH MASTER PROTECT H1000 WATER REPELLANT, AS MANUFACTURED BY MASTER BUILDERS, INC. OR APPROVED EQUAL. L. CONSTRUCTION JOINTS: 1. WALKS - SEE SITE PLAN FOR LOCATIONS. INSTALL 1/2" PREMOLDED JOINT FILLER WITH TEAR-OFF STRIP AND CAULK WITH MASTERSEAL SL-2 SELF LEVELING SEALANT. DISCONTINUE REINFORCEMENT AT JOINTS. 2. CURBS - SEE SITE PLAN FOR LOCATIONS (ALIGN WITH CONSTRUCTION JOINTS IN WALKS). INSTALL 1/2" PREMOLDED JOINT FILLER WITH TEAR-OFF STRIP AND CAULK WITH MASTERSEAL NP-2 SEALANT. DISCONTINUE REINFORCING AT
- SUCH JOINTS AND INSTALL (2) #5 X 40 SMOOTH DOWELS WITH SLIP-SLEEVES (ON ONE SIDE) BETWEEN EACH 3. OTHER CONSTRUCTION JOINTS - REFER ELSEWHERE IN THESE DRAWINGS FOR LOCATIONS AND DETAILING. M. CONTROL JOINTS (NOT CONSTRUCTION JOINTS) IN EXTERIOR WALKS SHALL BE TOOLED-IN AT LOCATIONS SHOWN ON
- DRAMINGS. REINFORCING SHALL BE CONTINUOUS THROUGH SUCH CONTROL JOINTS.
- 6. NOT USED
- 7. NOT USED
- 8. NOT USED 9. NOT USED
- 10. NOT USED
- 11. SOIL EROSION AND SEDIMENT CONTROL A. ALL SEDIMENT AND EROSION CONTROL WORK SHALL BE THE RESPONSIBILITY OF THE CONTRACTOR. B. PURPOSE - ALL CONSTRUCTION ACTIVITIES INVOLVING THE REMOVAL OR DEPOSITION OF SOILS ARE TO BE PROVIDED WITH APPROPRIATE MEASURES TO MINIMIZE EROSION OF, AND CONTAIN SEDIMENT DEPOSITION, WITHIN THE AREA UNDER DEVELOPMENT. SOME SUCH METHODS ARE DESCRIBED HEREIN. HOWEVER, THE CONTRACTOR SHALL ADHERE TO THE REQUIREMENTS OF THE EROSION AND SEDIMENT CONTROL STANDARDS AND SPECIFICATIONS OF THE VILLAGE OF PIERMONT, THE SOIL EROSION AND CONTROL REGULATIONS PUBLISHED BY ROCKLAND COUNTY, AS WELL AS THE PUBLICATION ENTITLED NEW YORK STANDARDS AND SPECIFICATIONS FOR EROSION & SEDIMENT CONTROL.
- WHEREVER FEASIBLE, NATURAL VEGETATION SHALL BE RETAINED AND PROTECTED. ONLY THE SMALLEST PRACTICAL AREA OF LAND SHALL BE EXPOSED AT ANY ONE TIME DURING CONSTRUCTION. PRIOR TO THE START OF CONSTRUCTION TEMPORARY SEDIMENT BARRIERS, BALED HAY EROSION CHECKS, SILT FENCES AND OTHER APPROVED SEDIMENT CONTROL PRACTICES SHALL BE IN PLACE WHERE NECESSARY.
- 4. SITE CONSTRUCTION ACTIVITIES SHALL START, WHENEVER POSSIBLE, AT THE NEAREST POINT UPSLOPE OF SOIL EROSION AND SEDIMENT CONTROL PRACTICES AND SHALL PROCEED TO ACTIVITIES FURTHER UPSLOPE. 5. SILT TRAPS AND OTHER PRACTICES SHALL BE CLEANED OUT WHEN THE ACCUMULATED SEDIMENT HAS REDUCED THE CAPACITY OF THE PRACTICE BY APPROXIMATELY 50%. SEDIMENT REMOVED FROM THE PRACTICE SHALL BE PROPERLY DISPOSED OF TO PREVENT ITS RE-ENTRANCE INTO THE PRACTICE OR ENTRANCE INTO A DRAINAGE SYSTEM. SMALL QUANTITIES OF SEDIMENT SHOULD BE PLACED BEHIND PROTECTIVE BERMS. LARGER QUANTITIES
- PROTECTIVE BERMS, AND SHALL BE VEGETATED. 6. WHEN LAND IS EXPOSED DURING DEVELOPMENT, THE PERIOD OF EXPOSURE SHALL BE KEPT TO A MINIMUM AND THE CONTRACTOR SHALL INSTALL PERMANENT AND FINAL VEGETATION, PAVING, ETC., AT THE EARLIEST POSSIBLE 7. ALL TEMPORARY EROSION AND SEDIMENT CONTROL PRACTICES SHALL REMAIN IN PLACE AND SHALL BE

SHOULD BE STOCKPILED A SUITABLE DISTANCE AWAY FROM DRAINAGE COURSES AND SHALL BE CONTAINED BY

- MAINTAINED REGULARLY IN PROPERLY FUNCTIONING CONDITION UNTIL ALL AREAS EXPOSED DURING SITE CONSTRUCTION HAVE BEEN SUITABLY STABILIZED WITH PERMANENT PAVING, AND/OR FINAL VEGETATIVE COVER. 8. THE CONTRACTOR SHALL INSTALL SEDIMENT BARRIERS AROUND EXISTING CATCH BASINS AND SOCKS SHALL BE INSTALLED IN THE CATCH BASINS AS REQUIRED TO PREVENT THE FLOW OF SILT INTO THE STORM WATER SYSTEM. SAME SHALL BE ACCOMPLISHED PRIOR TO THE IMPLEMENTATION OF SITE WORK, AND SUCH BARRIERS AND SOCKS
- SHALL BE REMOVED UPON THE COMPLETION OF THE RESPECTIVE WORK. D. SITE STABILIZATION ALL TOPSOIL TO BE STRIPPED FROM THE AREA BEING DEVELOPED SHALL BE STOCKPILED NOT LESS THAN 50-FEET FROM ANY ACTIVE DRAINAGE CONVEYOR AND SHALL BE LIMED, FERTILIZED AND SEEDED WITH A PERENNIAL OR ANNUAL RYE GRASS AT A RATE OF 1-1/2 POUNDS PER 1,000 SQUARE FEET. RECOMMENDED SEEDING DATES FOR ANNUAL AND PERENNIAL RYE GRASS ARE MARCH 15 TO JUNE 15 AND AUGUST 15 TO OCTOBER 15 (HOWEVER ACTUAL MEATHER CONDITIONS AT THE TIME SHALL PREVAIL) 2. ON ALL EMBANKMENT SLOPES, TOPSOIL SHALL BE STRIPPED AT LEAST 5-FEET WIDER THAN REQUIRED FOR THE EMBANKMENT TOE OF THE SLOPE. A PROTECTIVE BERM OF TOPSOIL SHALL BE LEFT IN THIS AREA RUNNING
- PARALLEL TO THE CONTOURS FOR THE PURPOSE OF RESTRICTING DRAINAGE RUNOFF. THE TOPSOIL BERM SHALL BE SEEDED AS REQUIRED FOR STOCKPILES. 3. ALL CUT SLOPES AND EMBANKMENT FILLS SHALL BE STABILIZED AS FOLLOWS: REMOVE LOOSE ROCK, CUT STONE AND CONSTRUCTION DEBRIS (APPROX 4 INCH SIZE) FROM THE AREA. PERFORM ALL CULTURAL OPERATIONS PARALLEL TO THE CONTOURS OF THE SLOPE.
- PLACE AT LEAST 4 INCHES OF TOPSOIL. SURFACES COMPACTED BY CONSTRUCTION MACHINERY SHOULD BE SCARIFIED BEFORE TOPSOIL IS PLACED 4. APPLY LIME ACCORDING TO SOIL TEST OR AT THE RATE OF 2 TONS GROUND LIMESTONE PER ACRE (100 POUNDS PER 1000 SQUARE FEET)
- E. REFER TO THE SOIL EROSION CONTROL PLAN AND DETAILS FOR ADDITIONAL REQUIREMENTS.

ABBREVIATIONS

AASHTO	AMERICAN ASSOCIATION OF STATE HIGHWAY AND TRANSPORTATION OFFICIALS
ACI	AMERICAN CONCRETE INSTITUTE
ADA	AMERICANS WITH DISABILITIES ACT
AFF	ABOVE FINISH FLOOR
LHA	AUTHORITY HAVING JURISDICTION
ALT	ALTERNATE
ANSI	AMERICAN NATIONAL STANDARDS INSTITUTE
APPROX	APPROXIMATE
ASCE	AMERICAN SOCIETY OF CIVIL ENGINEERS
ASTM	AMERICAN SOCIETY FOR TESTING AND MATERIALS
BB	BELGIAN BLOCK
BC	BOTTOM OF CURB
BET	BETWEEN
BIT	BITUMINOUS
BLDG	BUILDING
BLK	BLOCK
BRK	BRICK
ВТ	BOTTOM OF TRENCH
BM	BOTTOM OF WALL
CB	CATCH BASIN
	CAST IRON
ω	CONTROL JOINT
CL	CLEAR
CLF	CHAIN LINK FENCE
CMP	CORRUGATED METAL PIPE
CMU	CONCRETE MASONRY UNIT
0	CLEANOUT
COL	COLUMN
COMP	COMPRESSOR
CONC	CONCRETE
COND	CONDENSER
CONN	CONNECTION
CONST	CONSTRUCTION
CONT	CONTINUOUS
CONTR	CONTRACTOR
CR	CRACK
CU FT	CUBIC FEET
DBL	DOUBLE
DEPT	DEPARTMENT
DET	DETAIL
DIA	DIAMENTER
DIM	DIMENSION
OIP .	DUCTILE IRON PIPE
ON	DOWN
DMG	DRAWING
=	EAST
	EAST
E)	EXISTING, EXISTING TO REMAIN
EA	EACH
EL	ELEVATION
ELEC	ELECTRIC, ELECTRICAL
ENCL	ENCLOSURE
EQ	EQUAL
=5	EACH SIDE
EXP	EXPANSION
EM	EACH WAY
EXIST	EXISTING
EXP	EXPANSION
EXT	EXTERIOR
=ED	FEDERAL
=F	FINISH FLOOR
=IN	FINISH
=M	FILED MAP
=OUND	FOUNDATION
=T	FEET, FOOT
=TG	FOOTING
=~	FRONT YARD

GALLON, GALLONS

GALLONS PER DAY

GALLONS PER MINUTE

GROSS SQUARE FOOTAGE

HIGH-DENSITY POLYETHYLENE

HEATING, VENTILATION, AND AIR CONDITIONING

GALVANIZED

GAS VALVE

HORIZONTAL

HARD-PIPED

HOUR, HANDRAIL

(FIRE) HYDRANT

INSIDE DIAMETER

INFORMATION

LINE LOAD

INCLUDE, INCLUDING

KIPS PER SQUARE INCH

HANDICAP

MAXIMUM MANUFACTURER MANHOLE MINIMUM MINUTE MISCELLANEOUS MILLIMETER MANUAL ON UNIFORM TRAFFIC CONTROL DEVICES NORTH NOT APPLICABLE NOW OR FORMERLY NOMINAL DIMENSION, NOMINAL DIAMETER NOT IN CONTRACT NET SQUARE FOOTAGE NYCRR NEW YORK CODE OF RULES AND REGULATIONS NEW YORK STATE DEPARTMENT OF ENVIRONMENTAL CONSERVATION NYSDEC NYSDOT NEW YORK STATE DEPARTMENT OF TRANSPORTATION ON CENTER OUTSIDE DIAMETER OVERHEAD WIRES PERFORATED PERIMETER PKG POURED IN PLACE PREFAB PREFABRICATED POUNDS PER SQUARE FOOT POUNDS PER SQUARE INCH POUNDS PER SQUARE INCH - GAUGE (INCLUDING ATMOSPHERIC PRESSURE) POLYVINLYCHLORIDE RIM, RADIUS REINFORCED CONCRETE PIPE REINFORCE, REINFORCEMENT REQUIRED RETAINING ROOF LEADER REMOVE AND RELOCATE / REINSTALL REAR YARD SEPARATION STATE ENVIRONMENTAL QUALITY REVIEW (ACT) SEQR(A) SQUARE FEET SELF-LEVELING SPECIFICATION(S) STANDARD SPILL TO GRADE STORAGE STANDARD WEIGHT SIDE YARD SYSTEM TO BE DETERMINED TOP AND BOTTOM TOP OF CURB TEMPORARY THICKNESS TOP OF SLAB TOP OF WALL UNDERGROUND UNDERWRITERS LABORATORIES, INC. UNLESS OTHERWISE NOTED UTILITY POLE VERTICAL VERIFY IN THE FIELD MEST, MIDTH

WALL LIGHT, WATER LINE

WELDED WIRE REINFORCEMENT

MORK POINT

MATER VALVE

EXTRA HEAVY

MATER-RESISTANT

BATTOGLIA LANZA ARCHITECTURAL **GROUP PC**

209 OLD ROUTE 9, SUITE 5 FISHKILL, NEW YORK 12524 (845) 896 6771 PHONE (845) 896 6990 FACSIMILE blag@optonline.net

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IT IS A VIOLATION OF THE NEW YORK STATE EDUCATION LAW FOR ANY PERSON, UNLESS DESIGN PROFESSIONAL TO ALTER ANY ITEM IN ANY WAY ON A DOCUMENT BEARING THE SEAL LICENSED DESIGN PROFESSIONAL SHALL AFFIX THE NOTATION "ALTERED BY" FOLLOWED BY HIS / HER SIGNATURE AND THE DATE OF SUCH ALTERATION, AS WELL AS A SPECIFIC DESCRIPTION OF THE ALTERATION.



BERNARD J. LANZA - NY LICENSE NO. 17638 **REGISTRATION EXPIRES 5-31-27** DEBORAH C. LANZA - NY LICENSE NO. 29868 **REGISTRATION EXPIRES 11-30-26**

ISSUED FOR SITE PLOPING AND BIDDING APPROVALY NOT FOR

PROPOSED EXTERIOR INPROVEMENTS TO

M&T BANK

527 PIERMONT AVENUE VILLAGE OF PIERMONT COUNTY OF ROCKLAND, NEW YORK

REVISION SCHEDULE

5-15-25 ADDED REFERENCE TO SECTIONS 239-L AND 239-M OF GML, ADDED C AND REVISION DATES TO INDEX

DESCRIPTION

COVER SHEET - NOTES

PROJECT NUMBER: DRAWN BY:

CHECKED BY:

MAY 8, 2025

4. NOT USED

OF A BID.



ZONING AND OTHER DATA

ITEM	REGULATION	EXISTING CONDITION	PROPOSED CONDITION
OWNER / APPLICANT		MANUFACTURERS AND TRADERS TRUST COMPANY (M&T BANK)	MANUFACTURERS AND TRADERS TRUST COMPANY (M&T BANK)
OWNER'S / APPLICANT'S ADDRESS		ONE M&T PLAZA, BUFFALO, NY 12403	ONE M&T PLAZA, BUFFALO, NY 12403
OWNER'S REPRESENTATIVE PHONE NUMBER (ARCHITECT)		845-896-6771	845-896-6771
TAX MAP NUMBER OF PROPERTY		75.54-2-24	75.54-2-24
ADDRESS OF PROPERTY		527 PIERMONT AVE, PIERMONT NY 10968	527 PIERMONT AVE, PIERMONT NY 10968
ZONING DISTRICT	VILLAGE OF PIERMONT ZONING MAP	CBM - CENTRAL MULTI-USE BUSINESS	CBM - CENTRAL MULTI-USE BUSINESS
SCHOOL DISTRICT		SOUTH ORANGETOWN CENTRAL SCHOOL DISTRICT	SOUTH ORANGETOWN CENTRAL SCHOOL DISTRICT
AMBULANCE DISTRICT		SOUTH ORANGETOWN AMBULANCE CORP	SOUTH ORANGETOWN AMBULANCE CORP
POSTAL DISTRICT		PIERMONT (10968)	PIERMONT (10968)
IRE DISTRICT		PIERMONT	PIERMONT
EMER DISTRICT		ORANGETOWN	ORANGETOWN
ERMITTED PRINCIPAL USES	PROFESSIONAL, GOVERNMENTAL AND BUSINESS OFFICES (BANKING) (§ 210-61.2,A AND GENERAL USE REGULATIONS PART 3)	BANKING	BANKING
ERMITTED ACCESSORY USES	ACCESSORY PARKING AND SIGNS (§ 210-61.3,A AND GENERAL USE REGULATIONS PART 3)	ACCESSORY PARKING AND SIGNS	ACCESSORY PARKING AND SIGNS
OT AREA	1,700 SF MINIMUM [§ 210-61.6,D,(1)]	16,922.03 SF	16,922.03 SF
OT WIDTH	25 FT MINIMUM [§ 210-61.6,D,(2)]	127' - 7 5/8"	127' - 7 5/8"
RONT YARD	O FT MINIMUM [§ 210-61.6,D,(3)]	46' - 8"	46' - 8"
IDE YARD	O FT MINIMUM, EXCEPT 10 FT MINIMUM IF A SIDE YARD IS PROVIDED [§ 210-61.6,D,(4)]	51' - 6" (EAST) 30' - 6 3/8" (WEST)	51' - 6" (EAST) 30' - 6 3/8" (WEST)
IDE YARD SUM TOTAL	O FT MINIMUM [§ 210-61.6,D,(5)]	82' - 0 3/8"	82' - 0 3/8"
BUILDING HEIGHT	3-STORIES / 35 FT MAXIMUM [§ 210-61.6,D,(7)]	1-STORY / 13' - 4"	1-STORY / 13' - 4"
BUILDING COVERAGE		1,556.63 SF (INCLUDING CANOPY)	1,556.63 SF (INCLUDING CANOPY)
UILDING FLOOR AREA		1,556.63 SF (INCLUDING CANOPY)	1,556.63 SF (INCLUDING CANOPY)
LOOR AREA RATIO (FAR)	1.0 MAXIMUM [§ 210-61.6,D,(8)]	(1,556.63 / 16,922.03 =) 0.092	(1,556.63 / 16,922.03 =) 0.092
AVING COVERAGE		10,356.83 SF (EXCLUDING UNDER CANOPY)	10,693.03 SF (EXCLUDING UNDER CANOPY
OTAL IMPERVIOUS COVERAGE		(1,556.63 + 10,356.83 =) 11,913.46 SF	(1,556.63 + 10,693.03 =) 12,249.66 SF [336.20 SF INCREASE OR (336.20 / 11,913.46 =) 2.82% INCREASE)
PFF-STREET PARKING	MINIMUM QUANTITY OF SPACES (§ 210-68) 1 SPACE PER 150 SF OR (1556.63 / 150 =) 11 SPACES	11 SPACES	11 SPACES
	MINIMUM SIZE OF SPACES (CHARLIE	9 FT WIDE X 18 FT LONG	9 FT WIDE X 18 FT LONG

BATTOGLIA LANZA ARCHITECTURAL GROUP PC

209 OLD ROUTE 9, SUITE 5 FISHKILL, NEW YORK 12524 (845) 896 6771 PHONE (845) 896 6990 FACSIMILE blag@optonline.net

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BERNARD J. LANZA - NY LICENSE NO. 17638 REGISTRATION EXPIRES 5-31-27

BERNARD J. LANZA - NY LICENSE NO. 17638 REGISTRATION EXPIRES 5-31-27 DEBORAH C. LANZA - NY LICENSE NO. 29868 REGISTRATION EXPIRES 11-30-26

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AND BIDDING
APPROVAL AND FOR
CONSTRUCTION
CONSTRUCTION

PROPOSED EXTERIOR INPROVEMENTS TO

M&T BANK

527 PIERMONT AVENUE VILLAGE OF PIERMONT COUNTY OF ROCKLAND, NEW YORK

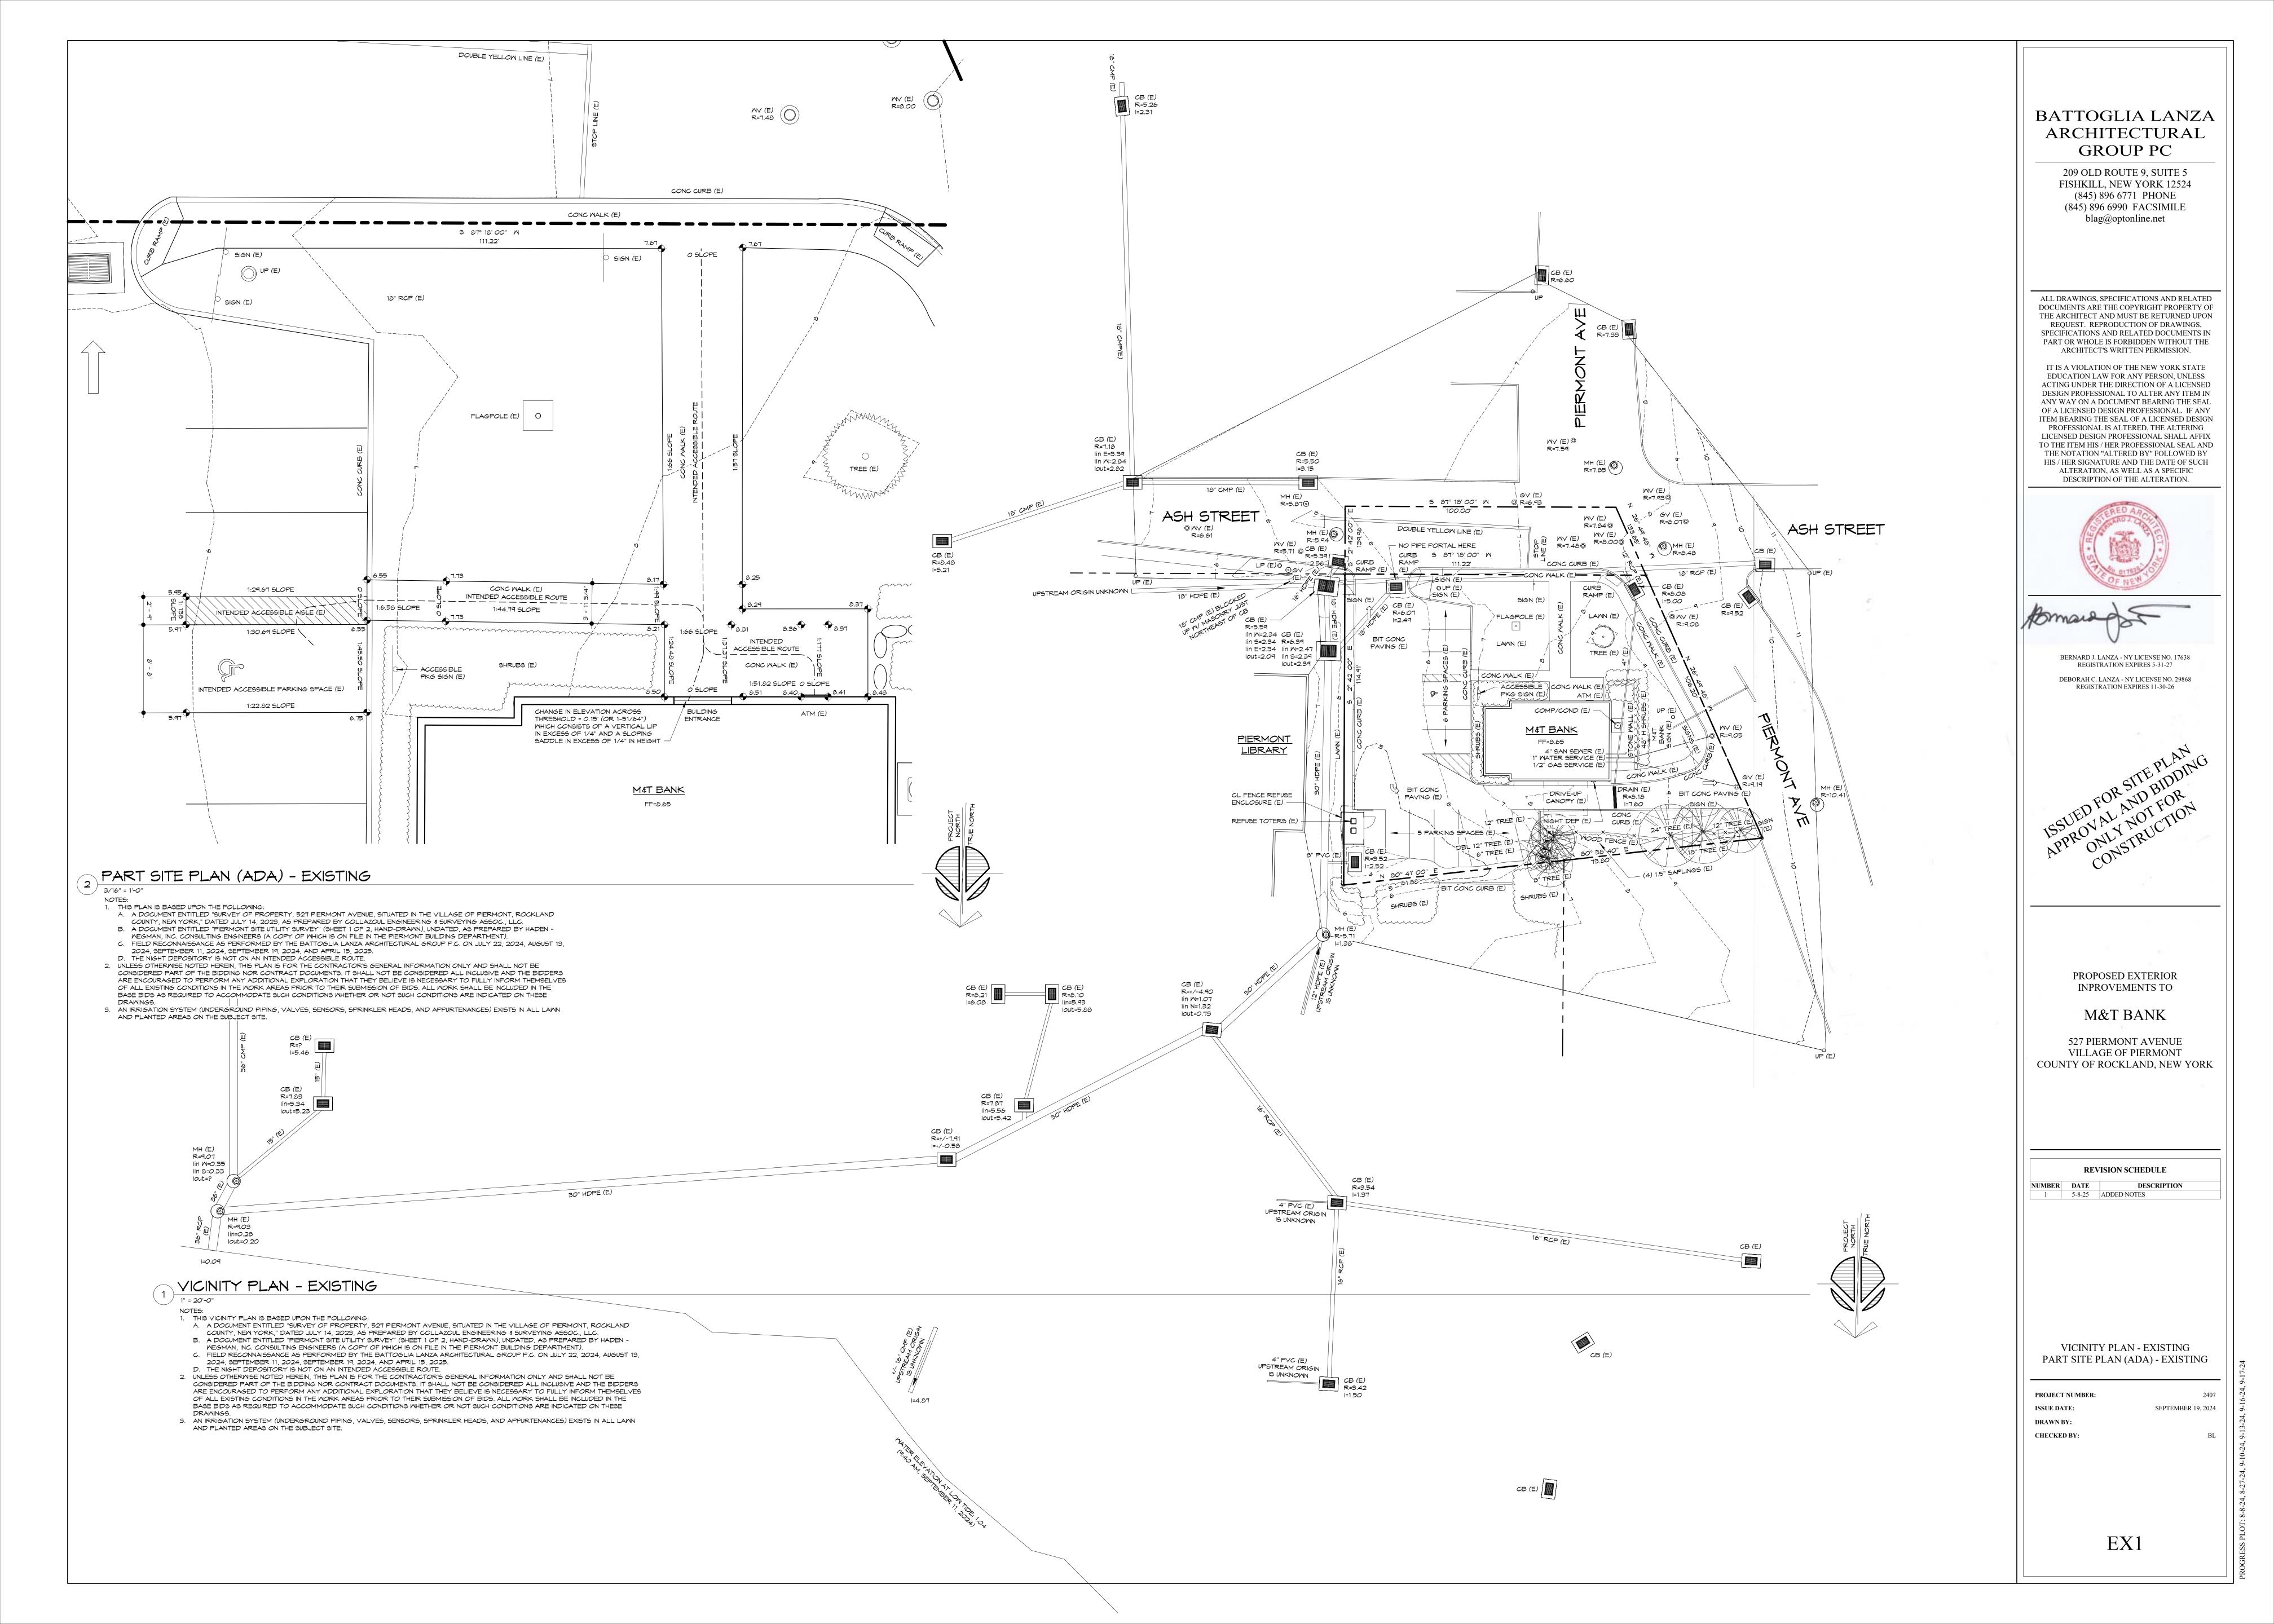
REVISION SCHEDULE

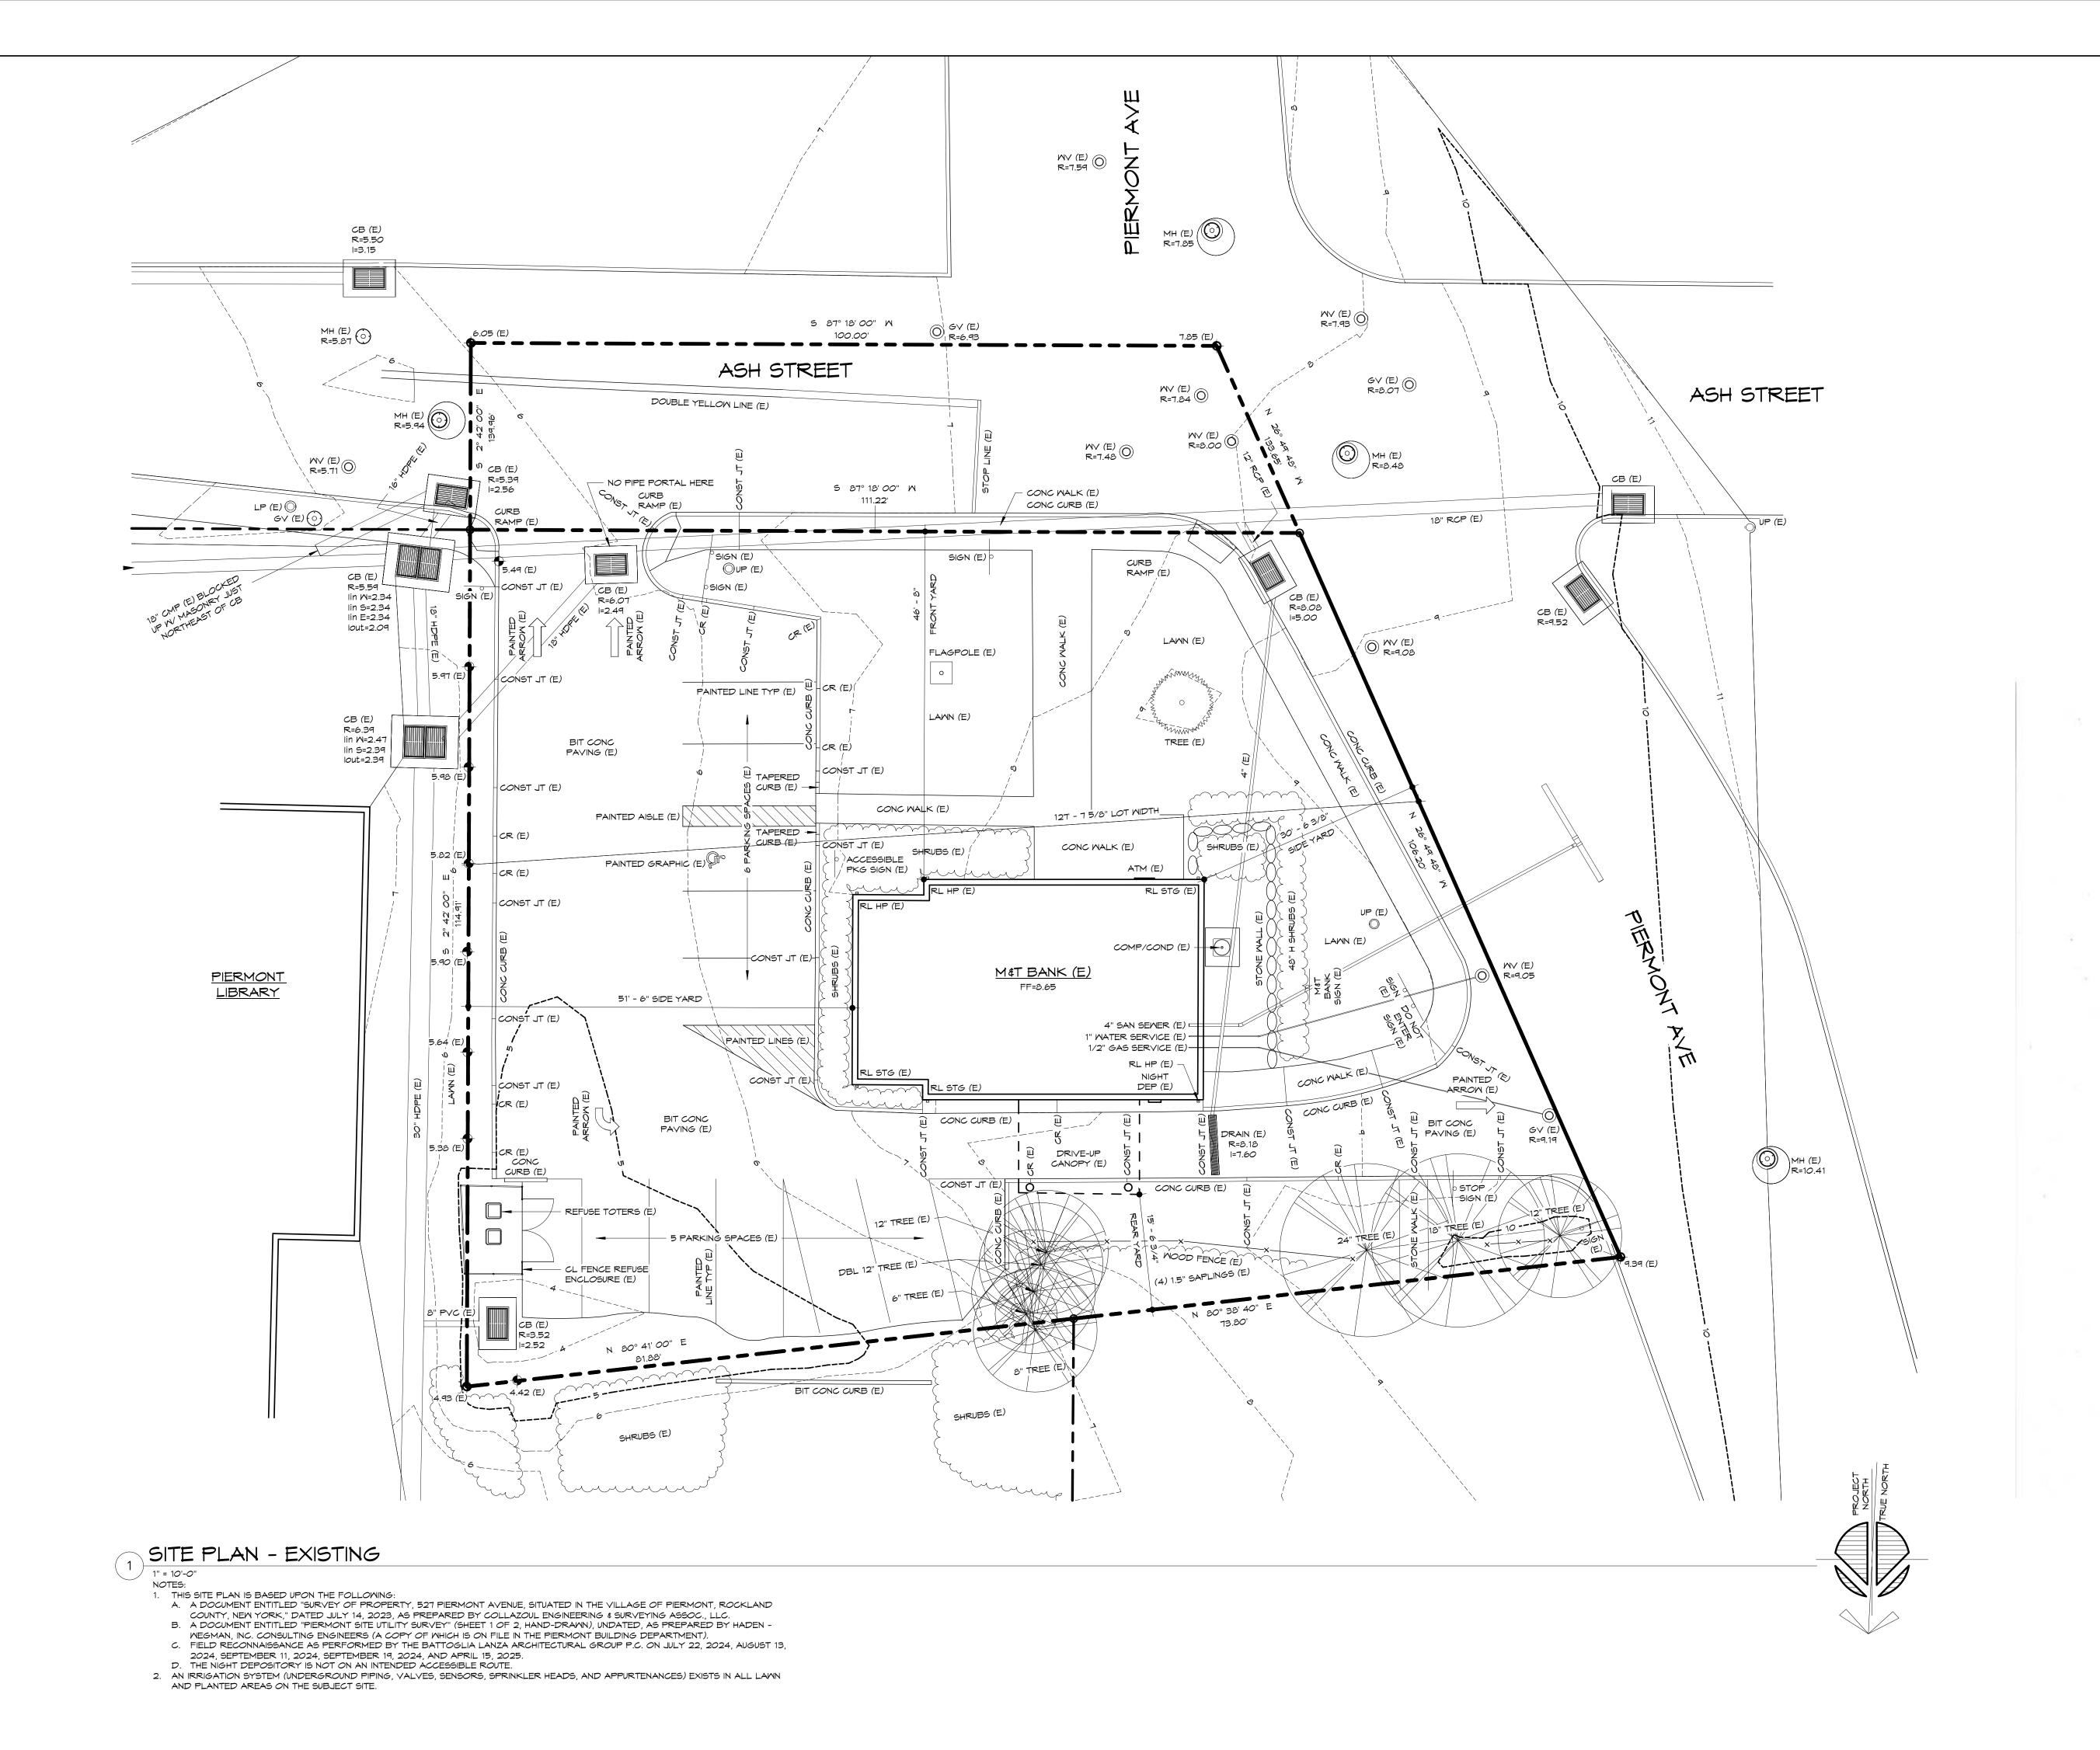
NUMBER DATE DESCRIPTION

LOCATION MAP - ZONING DATA

PROJECT NUMBER: 2407
ISSUE DATE: MAY 15, 2025
DRAWN BY:
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BERNARD J. LANZA - NY LICENSE NO. 17638 REGISTRATION EXPIRES 5-31-27 DEBORAH C. LANZA - NY LICENSE NO. 29868

REGISTRATION EXPIRES 11-30-26

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PROPOSED EXTERIOR INPROVEMENTS TO

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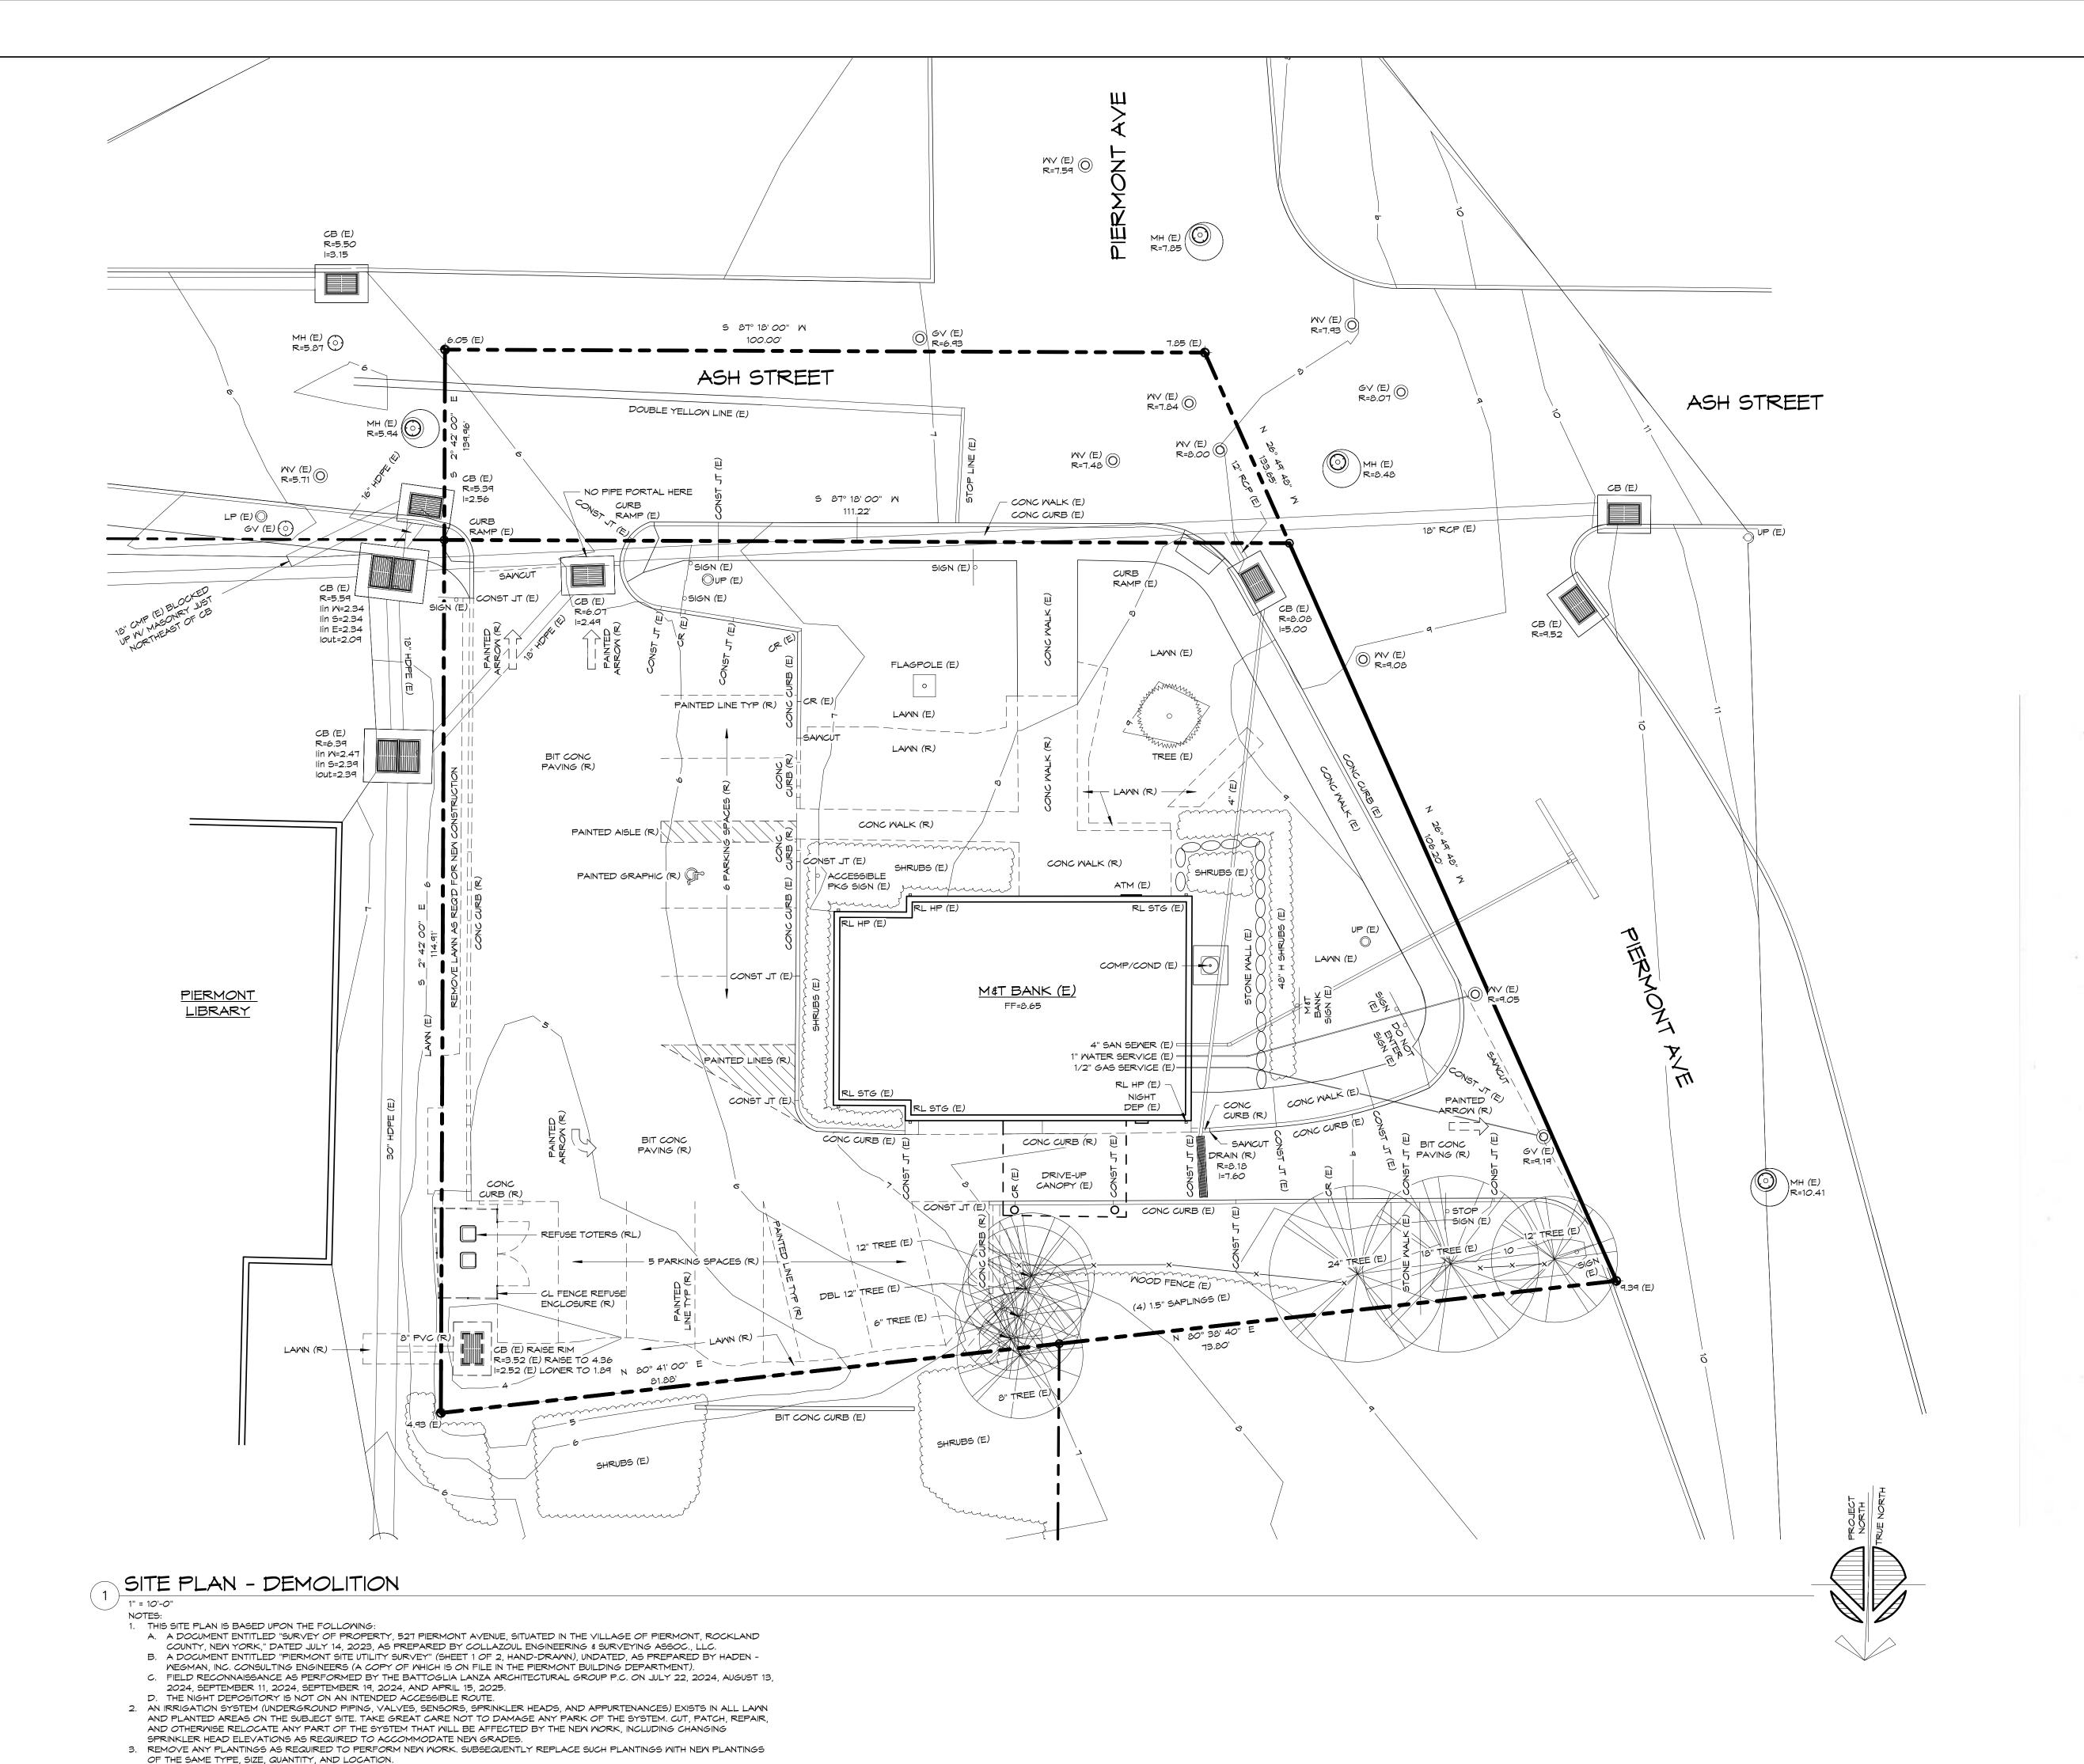
527 PIERMONT AVENUE VILLAGE OF PIERMONT COUNTY OF ROCKLAND, NEW YORK

REVISION SCHEDULE		
NUMBER	DATE	DESCRIPTION
1	5-8-25	ADDED INFORMATION AND NOTES
2	5-15-25	ADDED ZONING DIMENSIONS AND SPOT ELEVATIONS AT PROPERTY

SITE PLAN - EXISTING

PROJECT NUMBER: 2407
ISSUE DATE: MAY 8, 2025
DRAWN BY:
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EX2



4. REMOVE BITUMINOUS CONCRETE PAVING ON THE SITE IN ITS ENTIRETY UP TO THE SAWCUT LINES SPECIFIED AT EACH DRIVEWAY.

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DEBORAH C. LANZA - NY LICENSE NO. 29868 REGISTRATION EXPIRES 11-30-26

PROPOSED EXTERIOR INPROVEMENTS TO

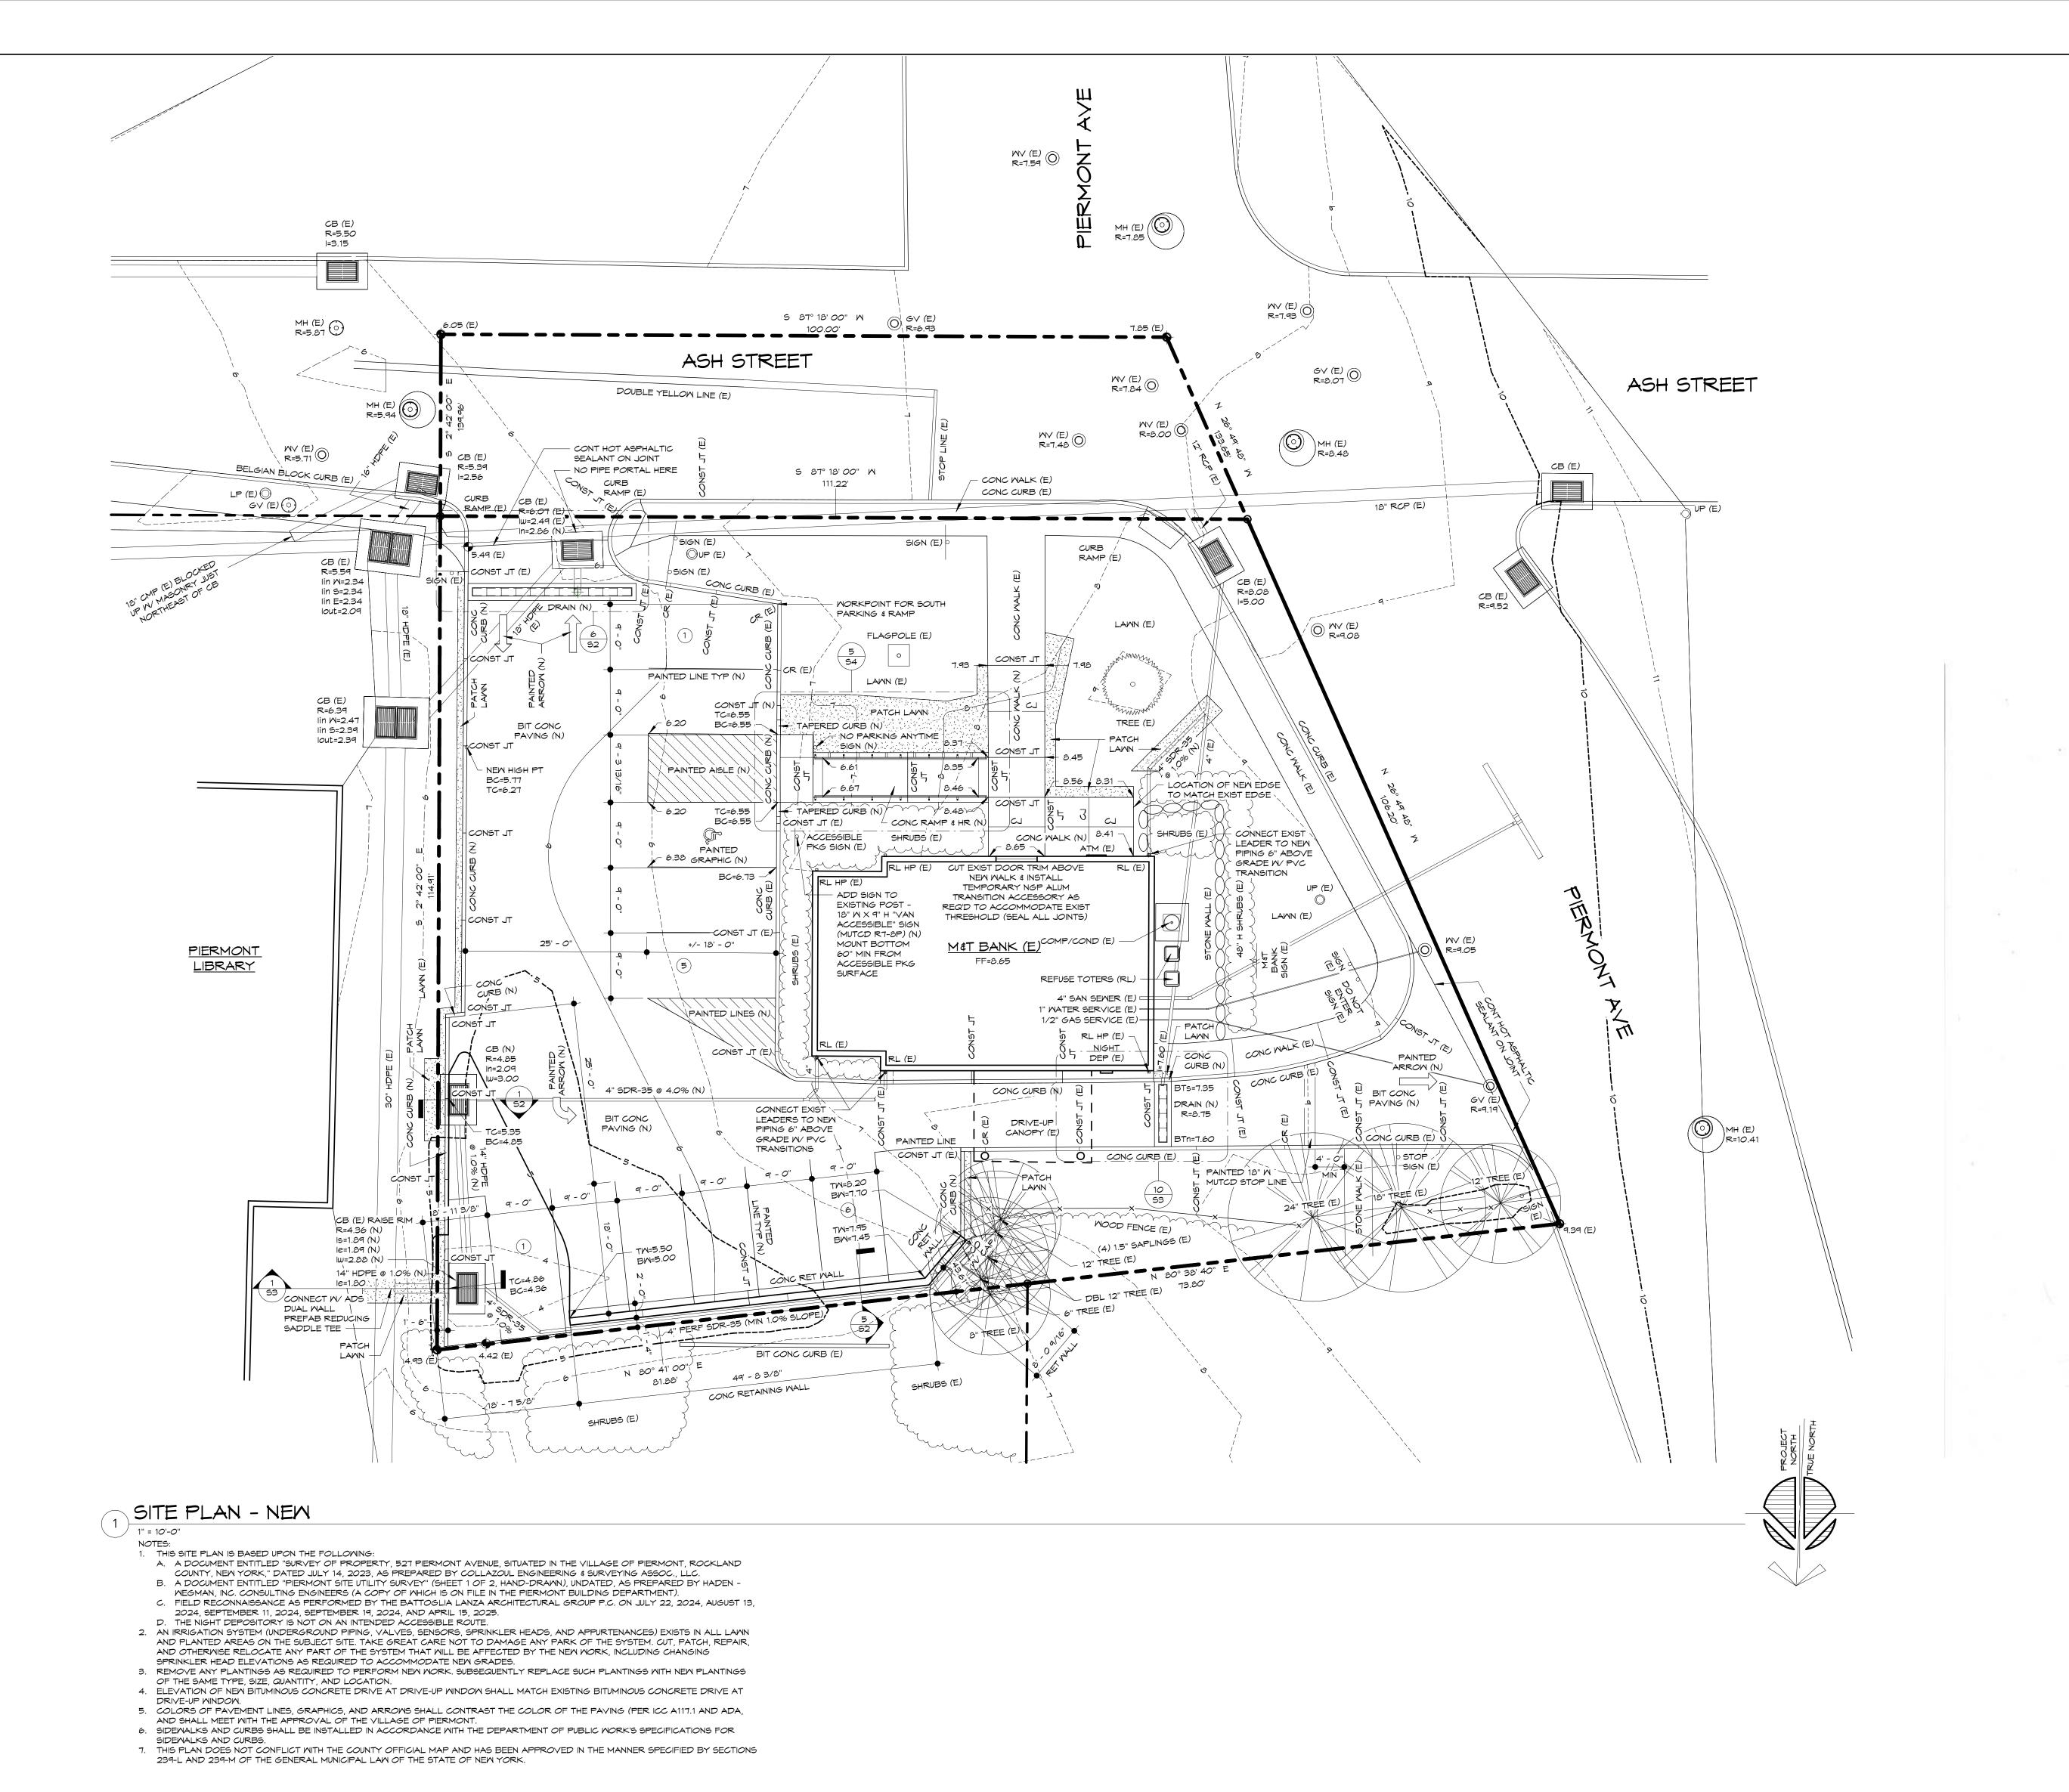
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REVISION SCHEDULE DESCRIPTION 5-8-25 ADDED NOTES 5-15-25 ADDED SPOT ELEVATIONS AT PROPERTY CORNERS

SITE PLAN - DEMOLITION

PROJECT NUMBER: **ISSUE DATE:** MAY 8, 2025 DRAWN BY: CHECKED BY:



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BERNARD J. LANZA - NY LICENSE NO. 17638 REGISTRATION EXPIRES 5-31-27 DEBORAH C. LANZA - NY LICENSE NO. 29868

REGISTRATION EXPIRES 11-30-26

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REVISION SCHEDULE

NUMBER DATE DESCRIPTION

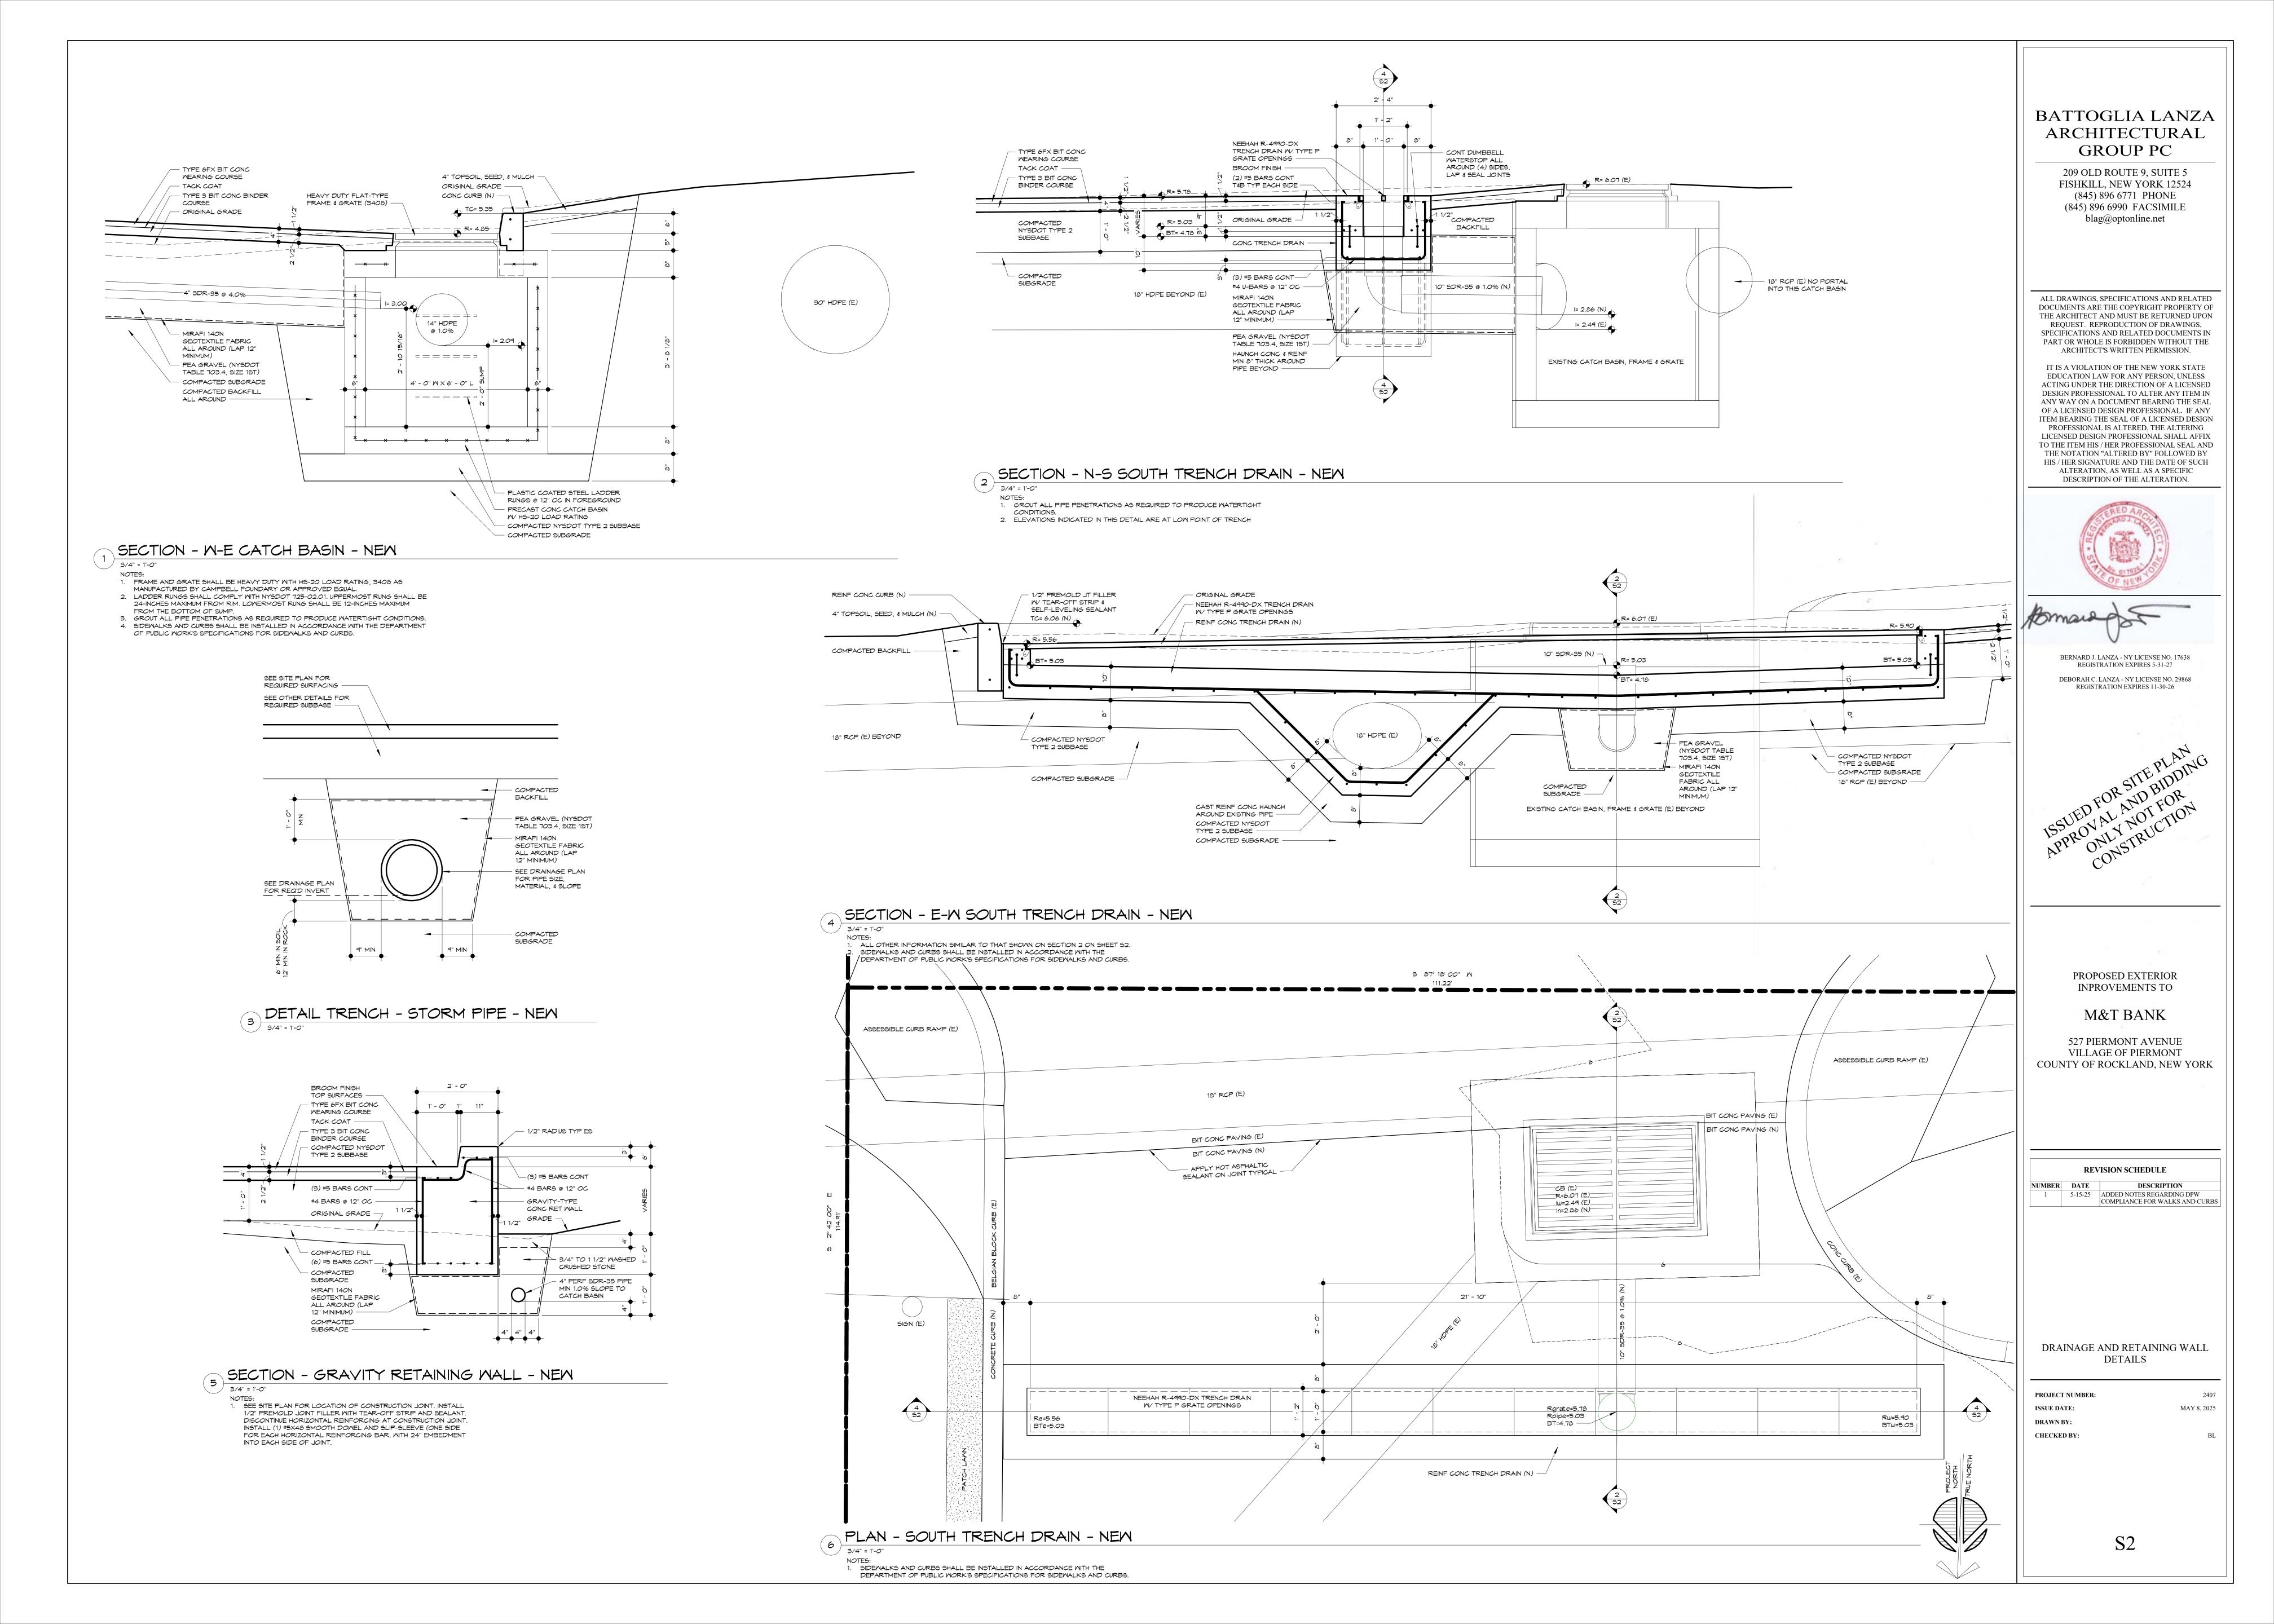
1 5-8-25 ADDED NOTES

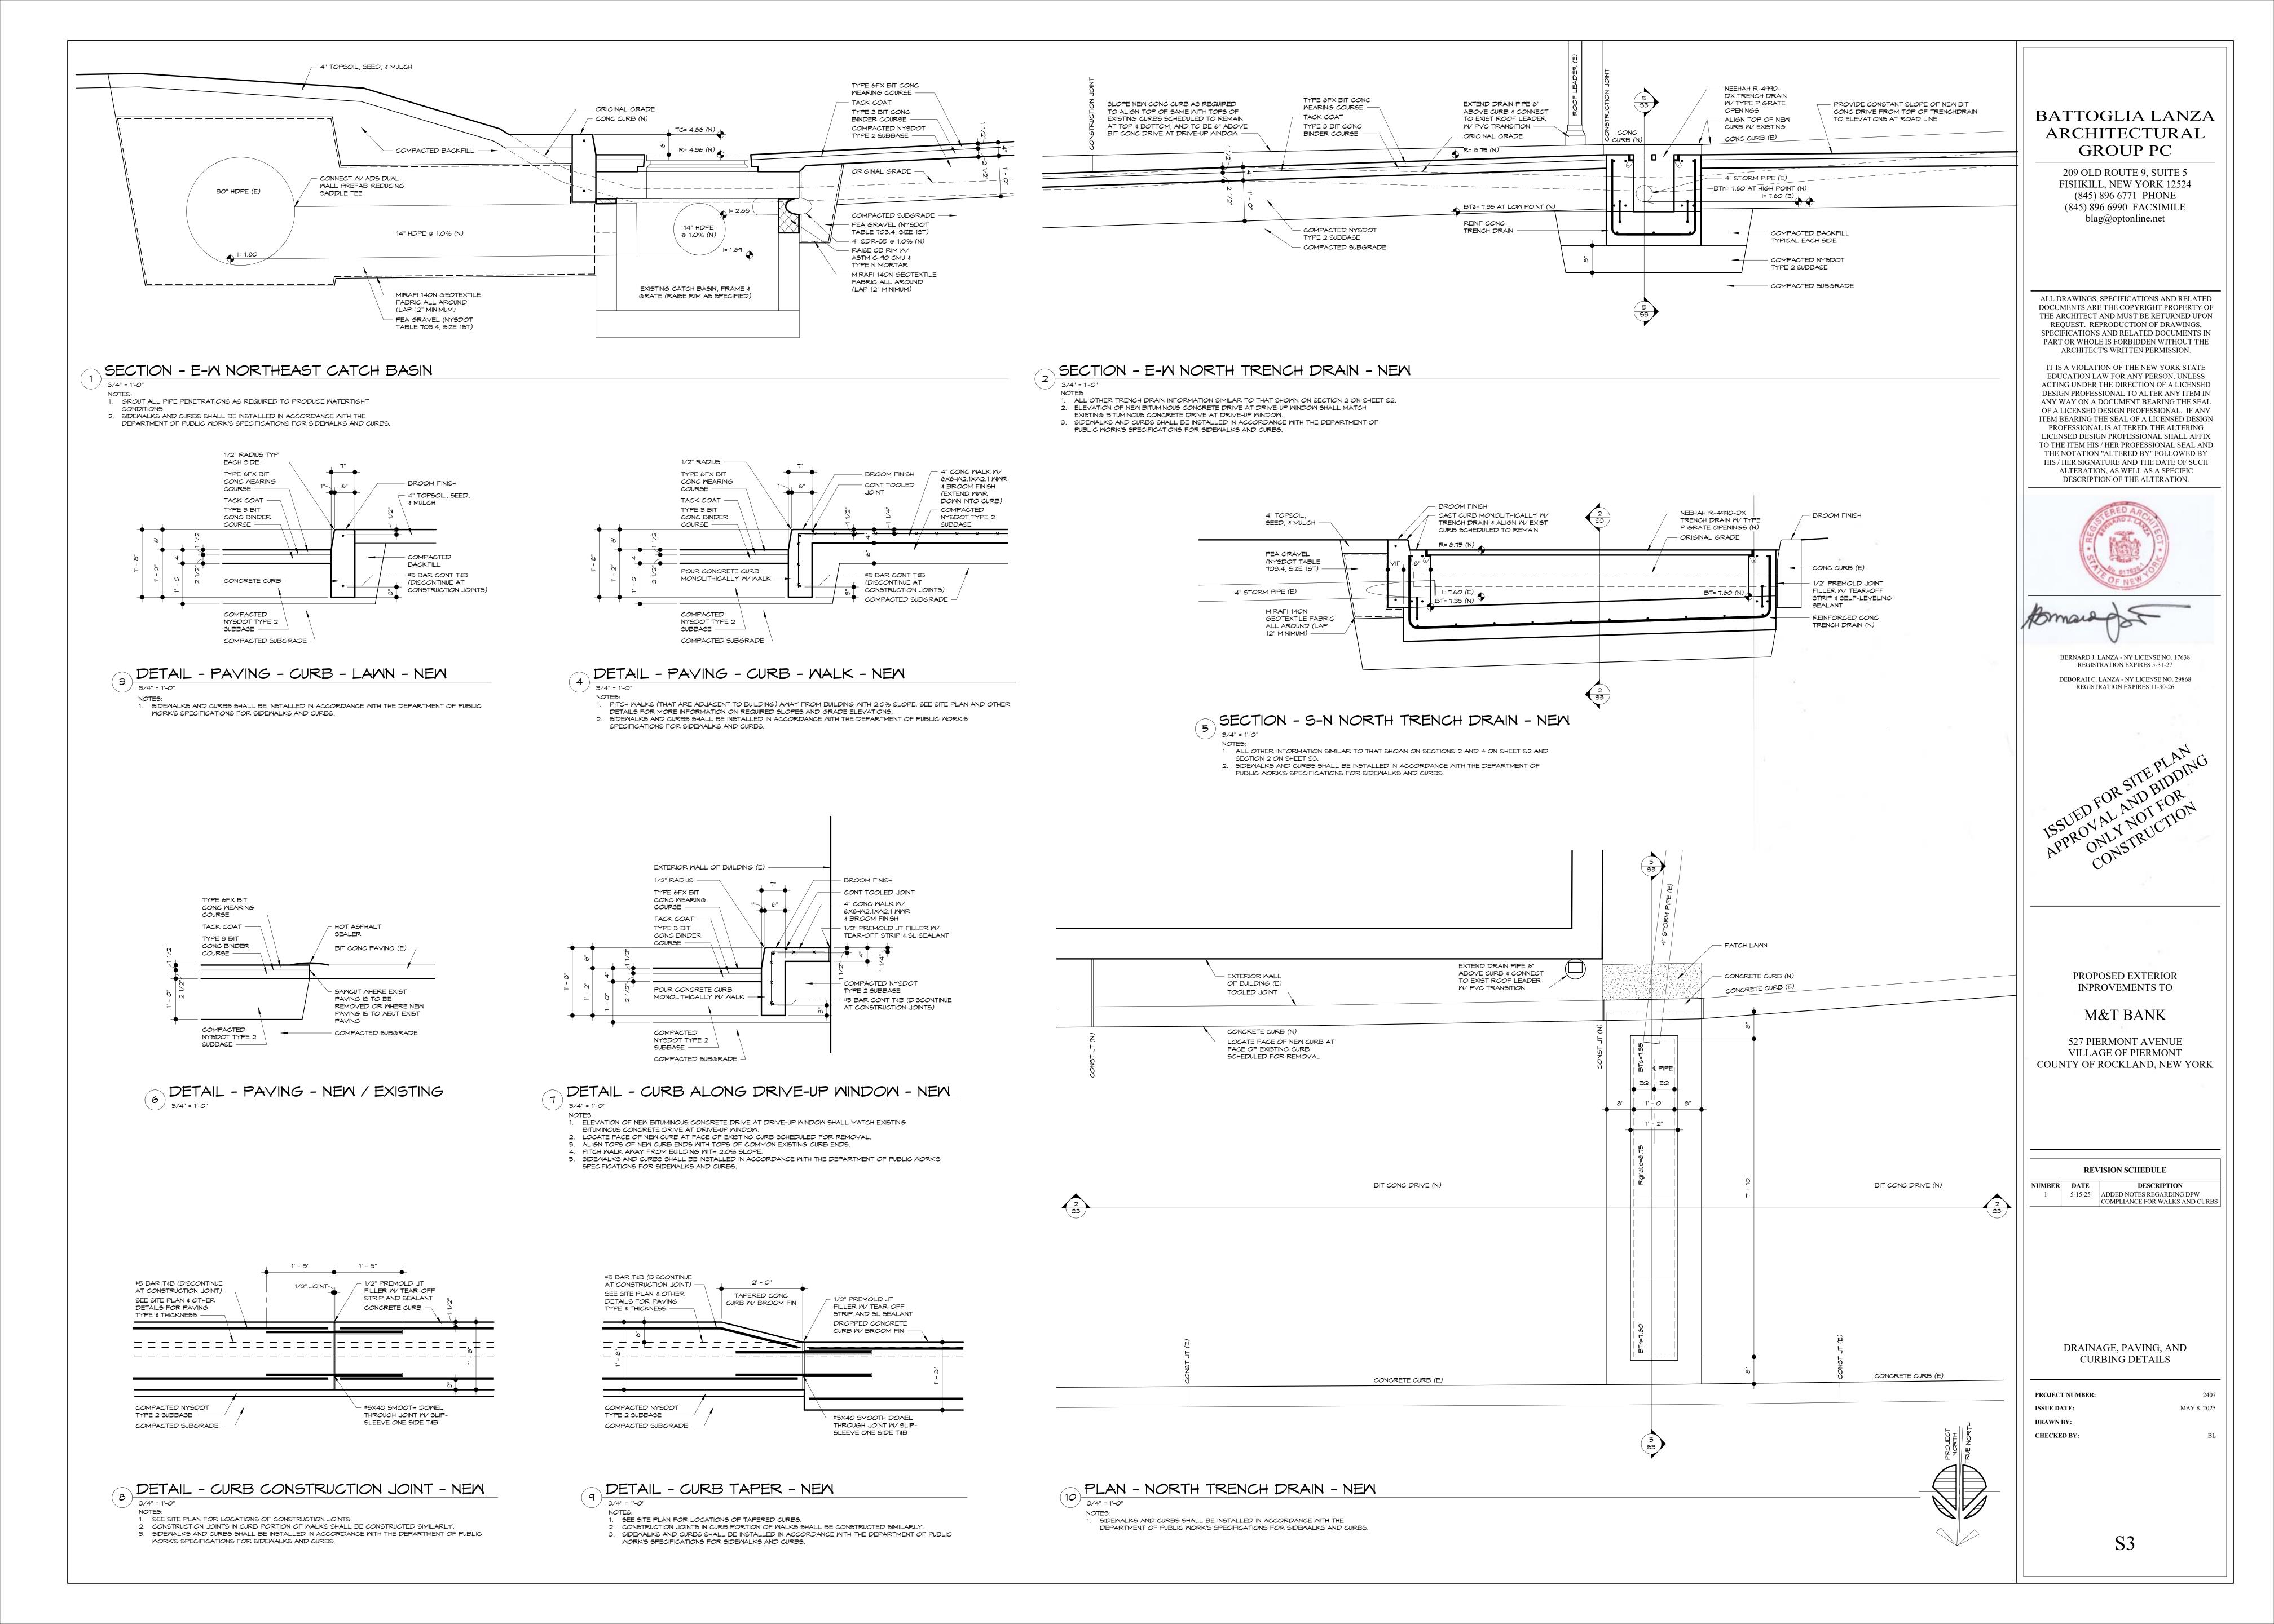
2 5-15-25 ADDED NOTES 6 AND 7. ADDED SPOT ELEVATIONS AT PROPERTY CORNERS

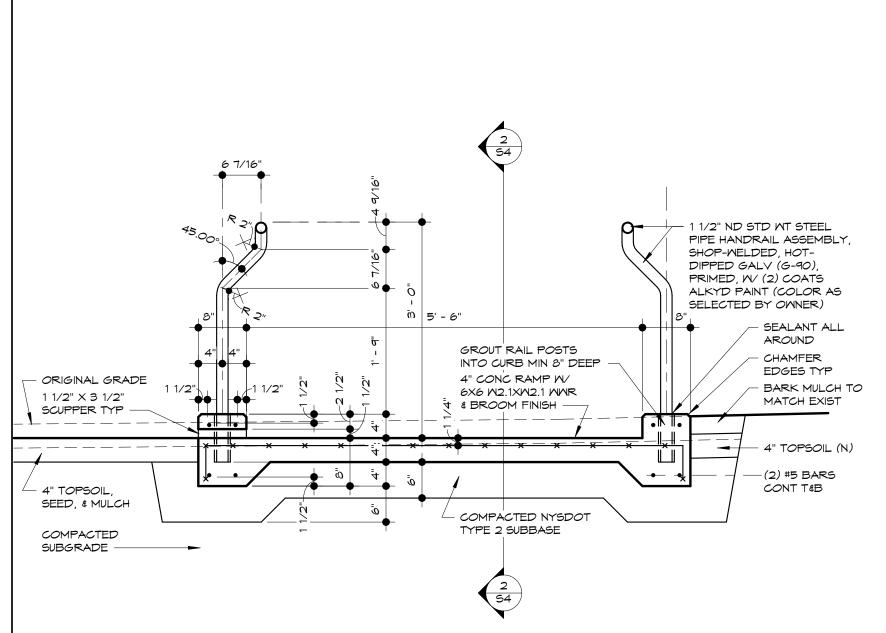
SITE PLAN - NEW

PROJECT NUMBER: 2407
ISSUE DATE: MAY 8, 2025
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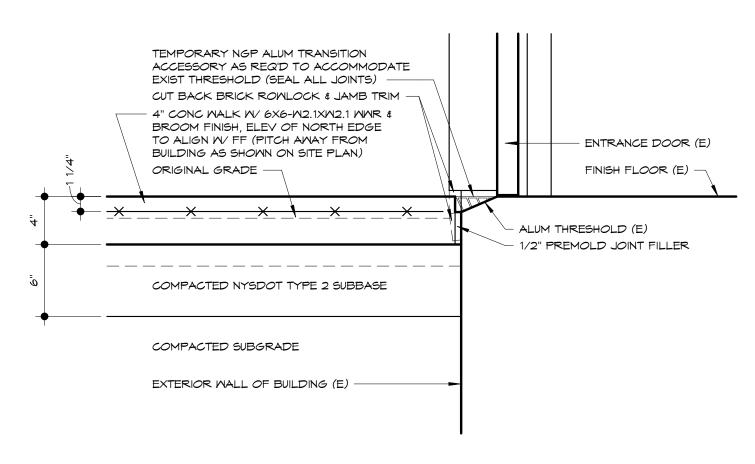
SECTION - S-N ACCESSIBLE RAMP - NEW

3/4" = 1'-0"

1. EACH SIDE OF RAMP SHALL BE CONSTRUCTED SIMILARLY UNLESS OTHERWISE NOTED.

. SEE PLAN 5 ON SHEET S4 FOR REQUIRED RUNNING SLOPE AND CROSS SLOPE. 3. CORE DRILL HOLES FOR RAIL POSTS MINIMUM OF (7) DAYS AFTER CONCRETE POUR. 4. DISCONTINUE HORIZONTAL REINFORCING AT CONSTRUCTION JOINT. INSTALL (1) #5X16 SMOOTH DOWEL AND SLIP-SLEEVE FOR EACH HORIZONTAL REINFORCING BAR WITH 8"

EMBEDMENT INTO EACH SIDE OF JOINT. 5. SIDEWALKS AND CURBS SHALL BE INSTALLED IN ACCORDANCE WITH THE DEPARTMENT OF PUBLIC WORK'S SPECIFICATIONS FOR SIDEWALKS AND CURBS.



DETAIL - WALK AT ENTRANCE

1. THIS PROJECT REQUIRES REMOVAL AND REPLACEMENT OF BARRIERS AND CONDITIONS THAT DO NOT COMPLY WITH ICC A117.1 AND ADA. IN THE CASE OF THE ENTRANCE DOOR, THE THRESHOLD WORK SPECIFIED HEREIN IS TEMPORARY. THE DOOR, AND HARDWARE (INCLUDING THE EXISTING THRESHOLD AND TEMPORARY TRANSITION ACCESSORY) WILL BE REMOVED AND REPLACED BY OTHERS IN THE FUTURE.

2. PREMOLD JOINT FILLER SHALL EXTEND ALONG THE SOUTH WALL OF THE BUILDINGTHE FULL LENGTH OF THE NEW CONCRETE WALK. SAME SHALL INCLUDE A TEAR-OFF STRIP, WHICH SHALL BE REMOVED AND CONTINUOUS

SELF-LEVELING SEALANT SHALL BE INSTALLED IN THE JOINT. 3. SIDEWALKS AND CURBS SHALL BE INSTALLED IN ACCORDANCE WITH THE DEPARTMENT OF PUBLIC WORK'S SPECIFICATIONS FOR SIDEMALKS AND CURBS.

ACCESSIBLE AISLE & PARKING SPACE MAXIMUM 2% SLOPE RAMP LANDING MAXIMUM 2.0% SLOPE 6' - 4" RAMP LANDING 21' - 6 1/16" RAMP MAXIMUM 2.0% SLOPE IN ANY DIRECTION MAXIMUM 8.33 % (1 \lor : 12 H) RUNNING SLOPE, MAXIMUM 2.0% CROSS SLOPE IN ANY DIRECTION IN ANY DIRECTION 11' - 8 13/16" 9' - 9 1/4" 4" 1' - 0" 1' - 0" 3' - 11" 3' - 11" 3' - 11" 3' - 11" 3' - 11" 2' - 3 1/2" 2' - 3 1/2" - 1 1/2" ND STD WT STEEL PIPE HANDRAIL ASSEMBLY, SHOP-WELDED, HOT-DIPPED GALV (G-90), PRIMED, W/ (2) COATS ALKYD PAINT (COLOR AS SELECTED BY OWNER) ┌ 1/2" PREMOLD JT FILLER M/ TEAR-OFF STRIP & SELF-LEVELING SEALANT - 1/2" PREMOLD JT - #5X16 SMOOTH DOWELS FILLER M/ TEAR-OFF @ 12" OC W/ SLIP-STRIP & SEALANT SCUPPER TYP -SLEEVES ON ONE SIDE - 1/2" PREMOLD JT FILLER POUR CONC CURB $_{ extstyle }$ 4" conc landing W/ 6x6-W/ TEAR-OFF STRIP & EDGES TYP -MONOLITHICALLY W2.1X2.1 WMR & BROOM FIN SELF-LEVELING SEALANT MITH RAMP -1/2" PREMOLD JT FILLER - #5X16 SMOOTH DOWELS M/ TEAR-OFF STRIP & 4" CONC RAMP W/ @ 12" OC W/ SLIP-SELF-LEVELING SEALANT 6X6-M2.1X2.1 MMR SLEEVES ON ONE SIDE ORIGINAL GRADE - TYPE 6FX BIT #5X16 SMOOTH DOWELS & BROOM FIN ---CONC WEARING @ 12" OC W/ SLIP-COURSE SLEEVES ON ONE SIDE -- TOOLED JOINT - TACK COAT - TYPE 3 BIT CONC — 4" CONC LANDING W/ 6X6-W2.1X2.1 WWR & BROOM FIN BINDER COURSE __ (2) #5 BARS (DISCONTINUE AT CONST JOINT) TC= 6.55 (N) (2) #5 BARS CONT ALL AROUND (DISCONTINUE AT CONST JOINT) - CONT 2X4 KEYWAY (TAIOL TEAOO - COMPACTED (2) #5 BARS SUBGRADE CONT -— (2) #5 BARS CONT ALL AROUND COMPACTED NYSDOT (DISCONTINUE AT CONST JOINT) TYPE 2 SUBBASE - CONT 2X4 KEYWAY - COMPACTED SUBGRADE - COMPACTED NYSDOT - #5 BAR CONT T&B TYPE 2 SUBBASE ACCESSIBLE CONC CURB W/ BROOM FINISH

SECTION - E-W ACCESSIBLE RAMP - NEW

1. UPPER REINFORCING FOR RAMP CURB NOT SHOWN FOR CLARITY. SEE SECTION 1 ON SHEET S4 FOR SAME. 2. SIDEMALKS AND CURBS SHALL BE INSTALLED IN ACCORDANCE WITH THE DEPARTMENT OF PUBLIC WORK'S SPECIFICATIONS FOR SIDEMALKS AND CURBS.

CONST JT (N) CONTROL JOINT SEE SITE PLAN FOR WORKPOINT FOR SOUTH PARKING AND ACCESSIBLE RAMP BIT CONC PAYING (N) PATCH LAWN AFTER GRADING AND OTHER MORK THAT DAMAGED SAME W/ 4" TOPSOIL, SEED, & MULCH? TC=6.55 BC=6.55 -CONST JT (N) CONCRETE WALK W/BROOM FINISH 1 1/2" ND STD WT STEEL PIPE HANDRAIL ASSEMBLY TYPICAL EACH SIDE OF RAMP, SHOP-WELDED, 12" M X 18" H "NO PARKING ANYTIME" MUTCD x-r7-1) HOT-DIPPED GALV (G-90), (N) MOUNT BOTTOM PRIMED, W/ (2) COATS 🗈 560" MIN FROM AISLE ALKYD PAINT (COLOR AS SURFACE SELECTED BY OWNER) POUR CURB MONOLITHICALLY SCUPPER WAMP TYPICAL EACH SIDE SCUPPER SCUPPER SCUPPER -SCUPPER CONST JT CONTROL JOINT 8.35 -**─** 6.61 | PAINTED LINES FOR ACCESSIBLE PARKING AISLE (N) 3' - 11" 3' - 11" 3' - 11" 2' - 3 1/2" 3' - 11" 3' - 11" 2' - 3 1/2" 6' - 4" RAMP LANDING 21' - 6 1/16" RAMP RAMP LANDING MAXIMUM 2% SLOPE IN ANY DIRECTION MAXIMUM 8.33 % (1 \lor : 12 H) RUNNING SLOPE, MAXIMUM 2% CROSS SLOPE MAXIMIM 2% SLOPE IN ANY 11' - 8 13/16" 9' - 9 1/4" 1' - 4" 5' - *0*" i DIRECTION CONCRETE RAMP W/ BROOM FINISH CONCRETE RAMP LANDING CONCRETE RAMP LANDING M/ BROOM FINISH M/ BROOM FINISH - 6.67 8.46 -- 8.48 CONST JT (N) TL TRNOO TC=6.55 BC=6.55 -REMOVE ANY PLANTINGS AS REQUIRED TO PERFORM NEW WORK. SUBSEQUENTLY REPLACE SUCH PLANTINGS WITH NEW PLANTINGS OF THE SAME TYPE, SIZE, QUANTITY, AND LOCATION. ACCESSIBLE PARKING CONCRETE WALK SPACE (N) W/ BROOM FINISH FLOWER BED & SHRUB AREA (E) (N) TL TENOS

PLAN - ACCESSIBLE RAMP - NEW

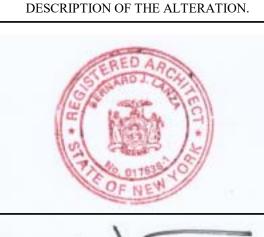
3/4" = 1'-0" . INFORMATION SHOWN FOR PAINTED LINES SHALL BE TYPICAL FOR PROJECT. 2. SIDEWALKS AND CURBS SHALL BE INSTALLED IN ACCORDANCE WITH THE DEPARTMENT OF PUBLIC WORK'S SPECIFICATIONS FOR SIDEMALKS AND

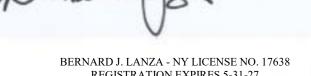
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REGISTRATION EXPIRES 5-31-27 DEBORAH C. LANZA - NY LICENSE NO. 29868 REGISTRATION EXPIRES 11-30-26



PROPOSED EXTERIOR INPROVEMENTS TO

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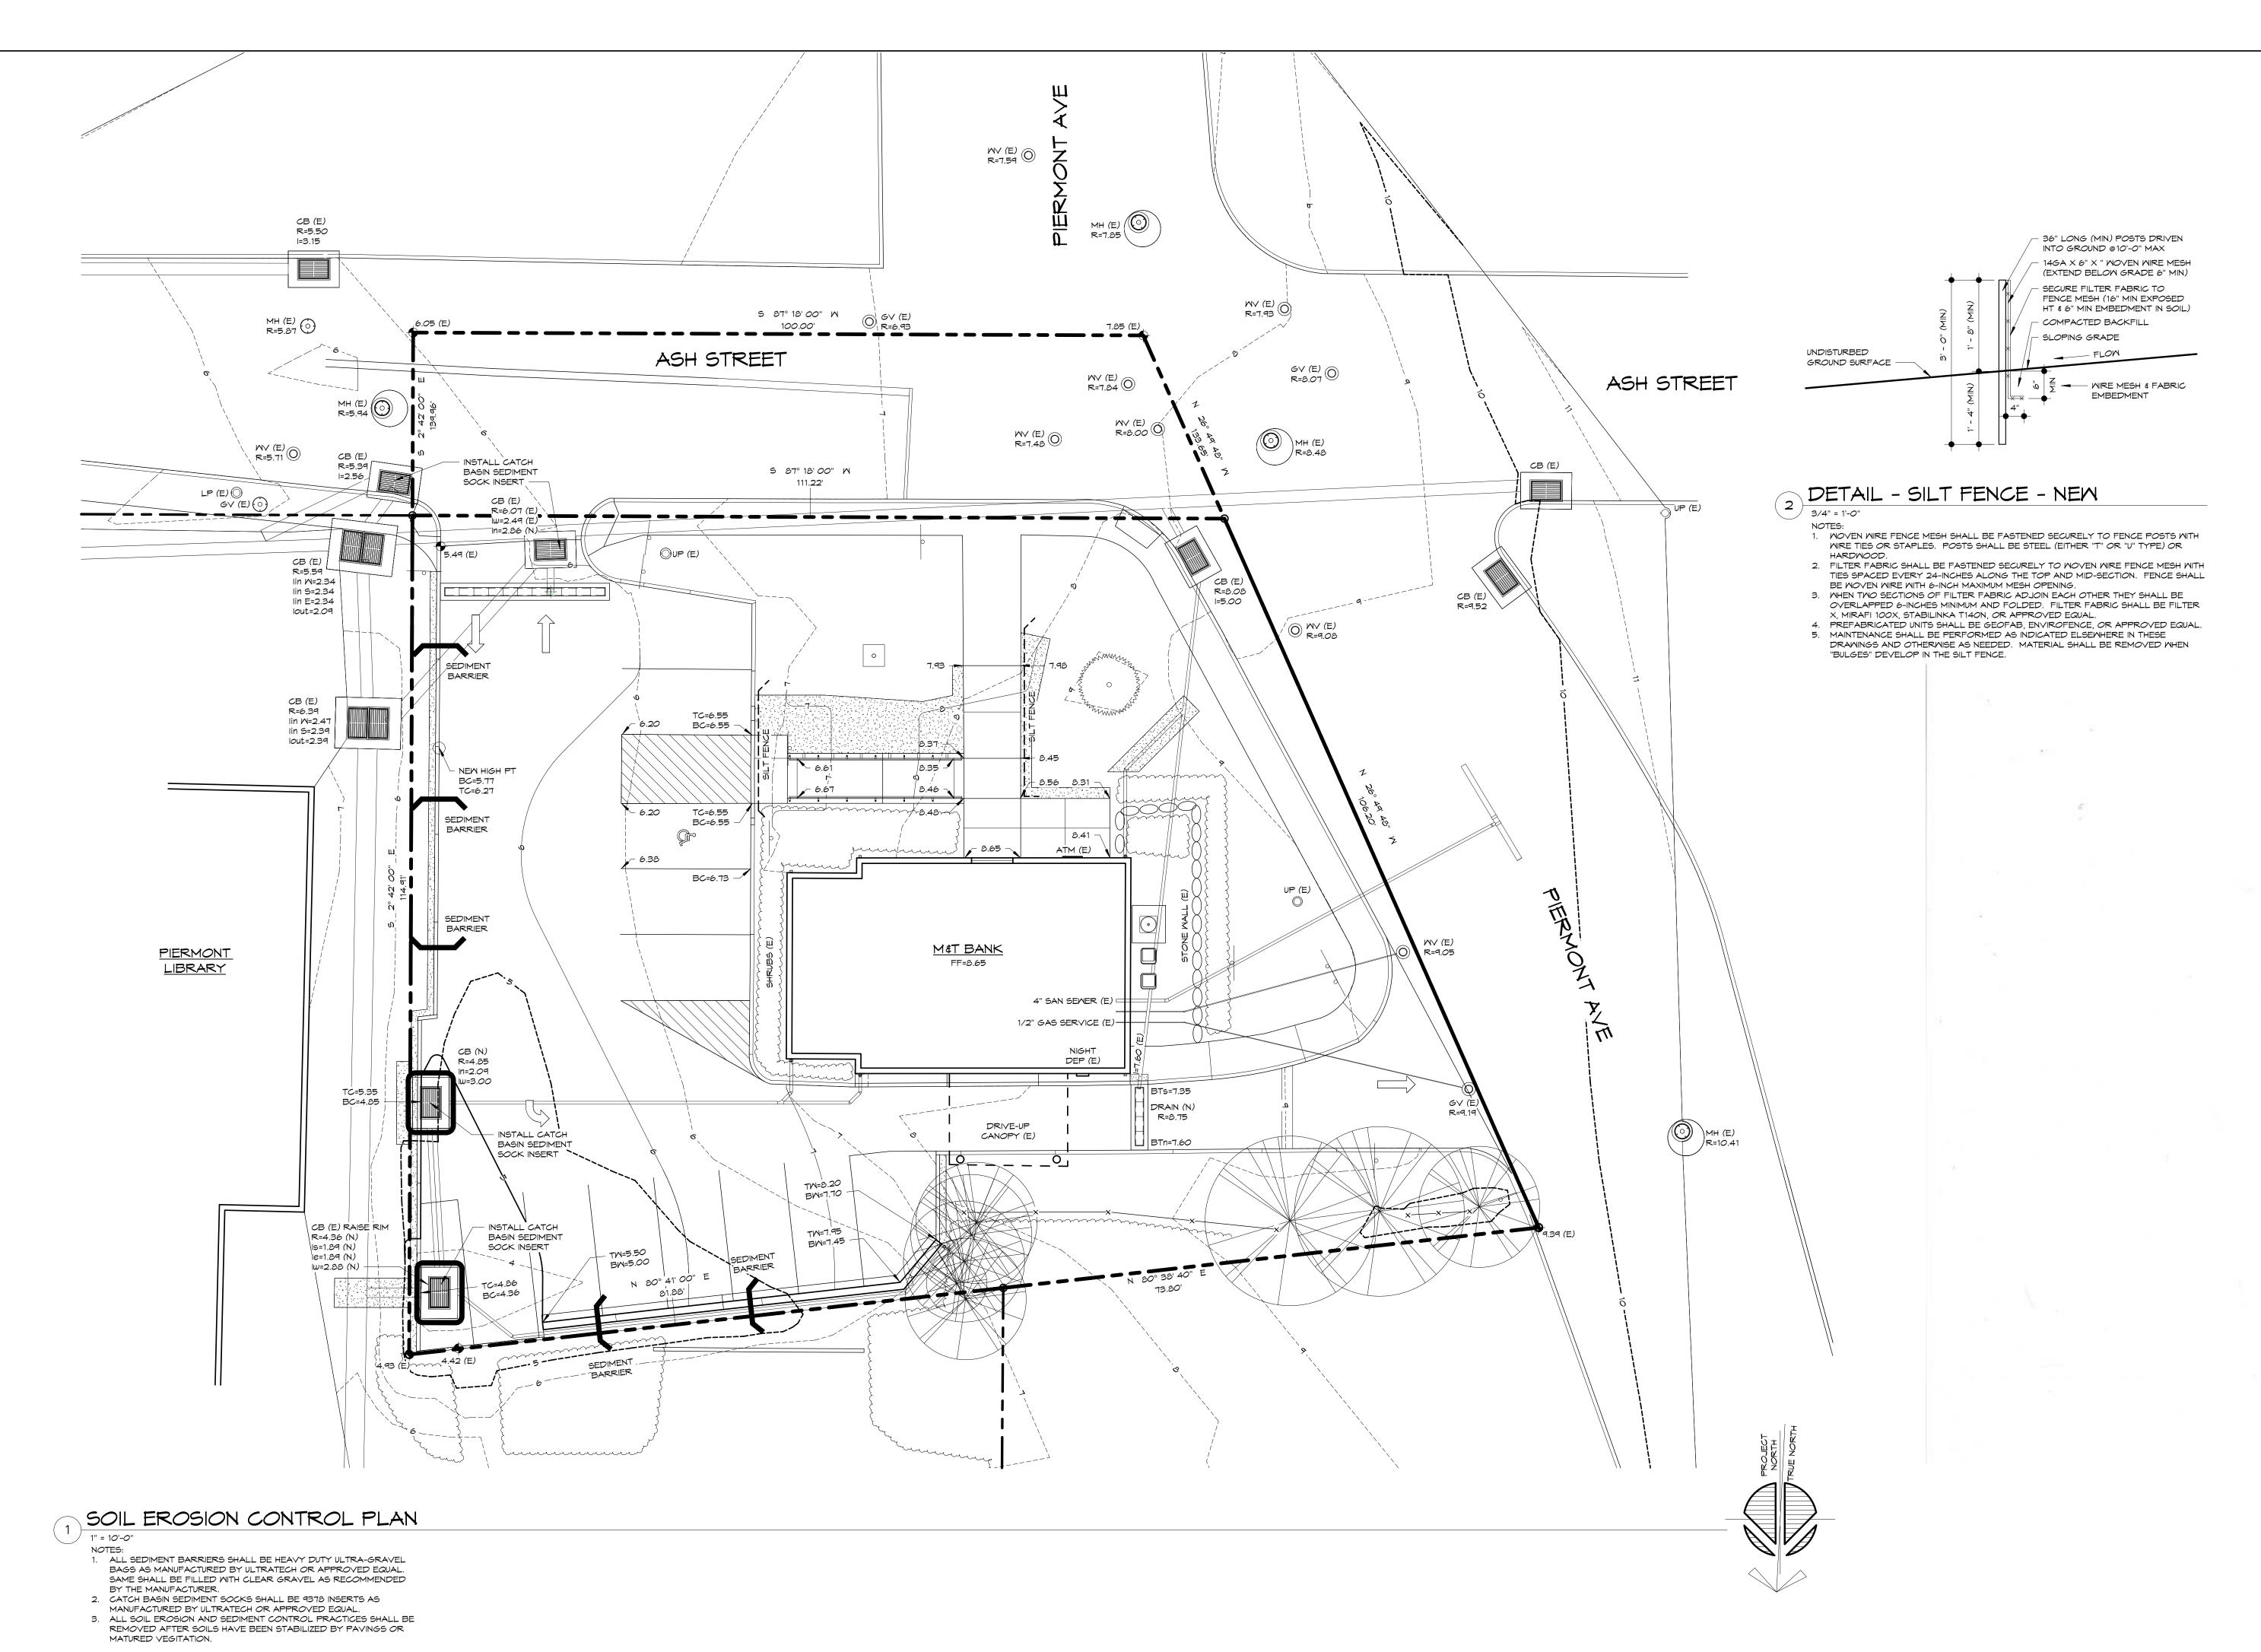
527 PIERMONT AVENUE VILLAGE OF PIERMONT COUNTY OF ROCKLAND, NEW YORK

REVISION SCHEDULE 5-15-25 ADDED NOTES REGARDING DPW COMPLIANCE FOR WALKS AND CURBS

ACCESSIBLE RAMP AND WALK **DETAILS**

MAY 8, 2025

PROJECT NUMBER: ISSUE DATE: DRAWN BY: CHECKED BY:



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527 PIERMONT AVENUE VILLAGE OF PIERMONT COUNTY OF ROCKLAND, NEW YORK

REVISION SCHEDULE		
NUMBER	DATE	DESCRIPTION
1	5-8-25	ADDED NOTES
2	5-15-25	ADDED SPOT ELEVATIONS AT
		PROPERTY CORNERS

SOIL EROSION CONTROL PLAN AND DETAIL

PROJECT NUMBER: 2407
ISSUE DATE: MAY 8, 2025
DRAWN BY:
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